

SINGLE-FAMILY ATTACHED HOMES

ADAMS COUNTY, COLORADO

PROJECT INTENT

On behalf of Urban Cottages, LLC, PCS Group is submitting an application for a Rezoning Map Amendment and PUD application for an approximately 1.81 acre site of vacant land located at 5350 Tejon Street. The site currently consists of undeveloped parcels and right of way. The project proposes

the construction of a maximum of 12 single-family attached/paired homes each with an ADU. Homes consist of four two-story plans that range in size from 890 to 1,850 s.f. The total project density will be approximately 6.6 du/ac.

The site design approach focuses on creating modestly sized homes on smaller lots. These 'missing middle' design features allow walkable, medium density, infill housing near public transportation and amenities. Missing middle housing caters to households usually overlooked in home design and planning, including seniors, singles, and young families.





Context Map



Site Location

CURRENT ZONING & USE:

The property is generally bounded by Tejon St. to the west, Raritan St. on the east, existing homes on Raritan Way. To the south and existing homes on Shoshone St on the north. The parcels requested for rezoning are as follows:

1. Parcel #: 0182516215009 2. Parcel #: 0182516215010 3. Parcel #: 0182516216011 4. Parcel #: 0182516216012 5. Parcel #: 0182516216013 6. Parcel #: 0182516216014 7. Parcel #: 018.82516216015




Conceptual Site Elements

Additionally, an existing, undeveloped portion of Raritan Way right of way is to be vacated.

Parcels 2 – 7 listed above are currently platted with 5 large home sites of about 8,700 square feet on a cul-de-sac right of way extended from Raritan Way. The parcels are vacant land bounded by existing fencing. Parcel 1 includes an existing single-family detached residence. The residential parcels are currently zoned R-1-C. An existing multi-family development, zoned R-3, is located directly east of the site. Residential properties are located on the north, south and western perimeters of the site and are zoned R-1-C.

PROPOSED USE:

The proposed use is for a maximum of 12 single-family attached/paired homes each with an ADU. The current zoning and plat encourage large homes on large lots, like those recently built to the north at Berkeley Pointe by Del-West. That form, if built here, will result in new home closing prices approaching \$1 million. The plan proposes smaller lot sizes and home sizes with an increased overall project density. The resulting single-family attached homes will target a value closer to half that of the what the current plat would produce.

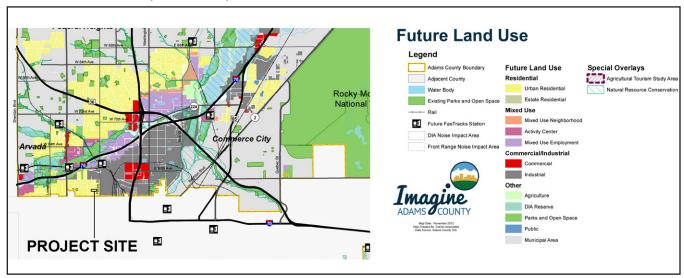

FUTURE LAND USE & PROJECT LOCATION

The site design approach focuses on creating modestly sized attached homes on smaller lots. These 'missing middle' design features allow walkable, medium density, infill housing near public transportation and amenities. 'Missing middle' housing caters to households usually overlooked in home design and planning, including seniors, singles, and young families.

ZONE CHANGE REQUEST

The proposed product type on an associated lot size is not permitted within the current zoning. Therefore, an application for a Zone Map Amendment request is being provided to the county.

COMPREHENSIVE PLAN COMPLIANCE

The project site is located with the Southwest Area Framework Plan as described in Policy 14 of the Comprehensive Plan. This portion of the county has been identified as an area of opportunity for future growth including development of unimproved enclaves, redevelopment of former industrial sites, development of commercial areas and improvement of commercial corridors. The project will be in compliance with Policy 14.5 of the Comprehensive Plan as outlined below:

Policy 14.5: Maintain and Enhance the Quality of Existing Residential Neighborhoods

14.5.a. Southwest Area Plan-County land use decisions will be consistent with the southwest Adams County Framework Plan.

Response: A residential project of this type at this location is similar in use with adjacent residential properties and is consistent with the policies and plans for growth per the Southwest Area Framework Plan.

14.5.b. Public Infrastructure Improvements—Continue to make public infrastructure improvements— such as installing curbs and gutters, improving roadways, pedestrian/trail connections, and park facilities—to enhance the image of established residential neighborhoods and improve the health and quality of life of area residents.

Response: The project will develop a missing portion of the adjacent neighborhood by providing new access points to adjacent streets, sidewalks and include manicured landscape areas with active and passive open space.

SITE DESIGN

Traffic & Vehicular Access

Primary vehicular access into the site will occur at one location coming off of Raritan Way to W. 53rd Drive. Raritan Way currently dead ends against the north project boundary. Homes will include two-car garages accessed from alleys intersecting the proposed private drive. In addition to the two-car garages for each home, there is a separate garage space for the ADU and there will be an additional 17 parrallel parking spots at the north end of the site



Pedestrian Access & Circulation

Homes will front the internal vehicular and pedestrian circulation network with access to the internal open space amenity area coming from a network of internal walks.

Utilities

Water service will be provided by North Lincoln Water and Sanitation District. A water mainline connection will be made to existing lines located in Raritan Way and Tejon St. The new water main associated with this project will complete a system loop desired by the District. A sanitary service connection will tie into a mainline in Raritan Way. Electric and gas will be provided by Xcel Energy.

Grading & Drainage

The site generally drains west to east with approximately 10 feet of grade differential. An underground detention basin will be located at the south boundary of the property. A storm line connection will be made to an existing line located in Raritan St. along the eastern property line.

Landscaping & Open Space

Landscape and open areas will be provided in accordance with development plan requirements. A minimum of 30% of open space will be required on site and 25% of the required open space will be used for active use. Open landscape areas will include areas of sod, shrubs, trees and planting beds as well as amenities such as a corn hole court, play area, and passive seating areas. Maintenance of these landscape areas will be provided by an HOA.

Architecture

These homes consist of four two-story plans that range in size from 890 to 1,850 square feet and boast contemporary and mountain modern elevation styles. The homes are designed as alley load and side loaded product that feature full front porches and open floor plans. With alley and side loaded garages, the front elevations are more attractive and open up to a green space. With larger covered front porches and small covered side porches, the outdoor living is maximized on these smaller lots. Buyers can choose to have a larger front porch to add even more outdoor living.



Conceptual Site Elements

WAIVER REQUESTS

1. Relevant code section: 5-03-02-02-01
Request a waiver permitting two new sf. residential homes to be constructed closer than the required 30' buffer adjacent to existing sf. development.

JUSTIFICATION: An existing sf residential structure is located within the 30' residential buffer to the south. This existing structure is to be removed and replaced with two new homes which will also be within the 30' buffer. the existing and proposed conditions will not be substantially different.

Relevant code section: 5-03-03-10
 Request waiver permitting the platting and construction of private drives (Raritan Way & Alleys)

JUSTIFICATION: Proposed alley and private drive network meets fire/life/safety requirements. The proposed road network provides vehicular connectivity with a smaller section than a full right of way.

3. 9-01-11-03-03 (Underground Detention)
Request waiver from underground detention.

JUSTIFICATION: Infill projects are challenged from numerous standard requirements imposed from a new project perspective and the proven innovation with this proposed solution provides a viable solution that will be maintained by the owner and not the County that will provide for an additional 2-4 attainable units providing additional housing within Adams County. Additionally this innovative solution provides for a better buffer, removal of unsightly drainage elements and a cohesive surface from the front of the units to the property line for more usable space.

PROJECT TIMEFRAME

The project is expected to be completed in a single phase beginning in the fourth quarter of 2023.

URBAN COTTAGES TEJON

LOTS 1-6 AND TRACT A, RARITAN ESTATES SUBDIVISION LOCATED IN THE NORTHWEST QUARTER OF SECTION 16, TOWNSHIP 3 SOUTH, RANGE 68 WEST, 6TH PRINCIPAL MERIDIAN COUNTY OF ADAMS, STATE OF COLORADO

PRELIMINARY ENGINEERING PLAN

LEGAL DESCRIPTION

LEGAL DESCRIPTION PER ALTA COMMITMENT ORDER NO. K70729405-2-LOTS 1, 2, 3, 5, 6 AND TRACT A RARITAN ESTATES SUBDIVISION COUNTY OF ADAMS, STATE OF COLORADO.

BASIS OF BEARINGS

BEARINGS SHOWN HEREON ARE ASSUMED AND ARE BASED UPON THE NORTHERLY LINE OF RARITAN ESTATES SUBDIVISION WHICH BEARS NORTH 89'48'50' WEST, BETWEEN THE MONUMENTS SHOWN HEREIN.

BENCHMARK


PROJECT BENCHMARK: #5 REBAR & 1-1/2" RED PLASTIC CAP, "PLS 27269", NORTHEAST CORNER OF TRACT A, RARITAN ESTATES SUBDIVISION. ELEVATION = 5293.43 (NAVD88).

BOARD OF COUNTY COMMISSIONS APPROVAL

APPROVED BY THE ADAMS COUNTY BOARD OF COMMISSIONERS ______ DAY OF _______ 20____.

PLANNING COMMISSION APPROVAL

APPROVED BY ADAMS COUNTY PLANNING COMMISSION THIS _____ DAY OF ______ 20___.

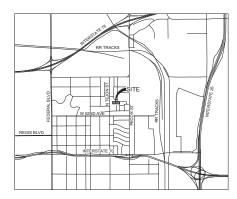

VICINITY MAP

Sheet List Table						
heet Number	Sheet Description					
1	COVER SHEET	CS1				
2	EXISTING CONDITIONS & DEMOLITION PLAN	DM1				
3	SITE PLAN	SP1				
4	OVERALL UTILITY PLAN	OU1				
5	OVERALL GRADING PLAN	GR1				
6	EROSION & SEDIMENT CONTROL PLAN	EC1				
7	CONSTRUCTION DETAILS: EROSION CONTROL	DT1				
9	CONSTRUCTION DETAILS - FROSION CONTROL	DT2				

OWNER:

URBAN COTTAGES, LLC 10657 E IDA AVENUE ENGLEWOOD, CO 80111 PHONE: 717.875.3961 CHASE STILLMAN

ENGINEER

CAGE CIVIL ENGINEERING 999 18TH ST, SUITE 2110 DENVER, CO 80202 PHONE: 720.206.6625 ERIC PEARSON

LANDSCAPE ARCHITECT

PCS GROUP 200 KALAMATH STREET DENVER, CO 80223 PHONE: 303.531.4905 ALAN CUNNINGHAM

SURVEYOR

EMK CONSULTANTS, INC.
7006 SOUTH ALTON WAY, BLDG. F
CENTENNIAL, CO 80112
PHONE: 303.694.1520
STEPHEN HARDING

FIRE FLOW DATA


THE MINIMUM FIRE-FLOW RATE THAT MUST BE PROVIDED BY THE WATER DISTRIBUTION SYSTEM IS 1000 GALLONS PER MINUTE WITH A 11R DURATION PER THE 2009 IFC, SECTION B105.1 OF APPENDIX B FOR THE PROPOSED SINGLE FAMILY HOMES.


SITE DATA TABLE		
NUMBER OF LOTS	12	
MINIMUM LOT SIZE	3,051 S.F.	
MINIMUM LOT WIDTH	30.0"	
NUMBER OF DWELLING UNITS	24	
ACREAGE OF AREA TO BE SUBDIVIDED	1.81 AC.	
ACREAGE OF PUBLIC RIGHT-OF-WAY	0.00 AC.	
ACREAGE OF PUBLIC AREAS	0.00 AC.	
ACREAGE OF COMMON AREA TRACTS	0.84 AC.	





CS1




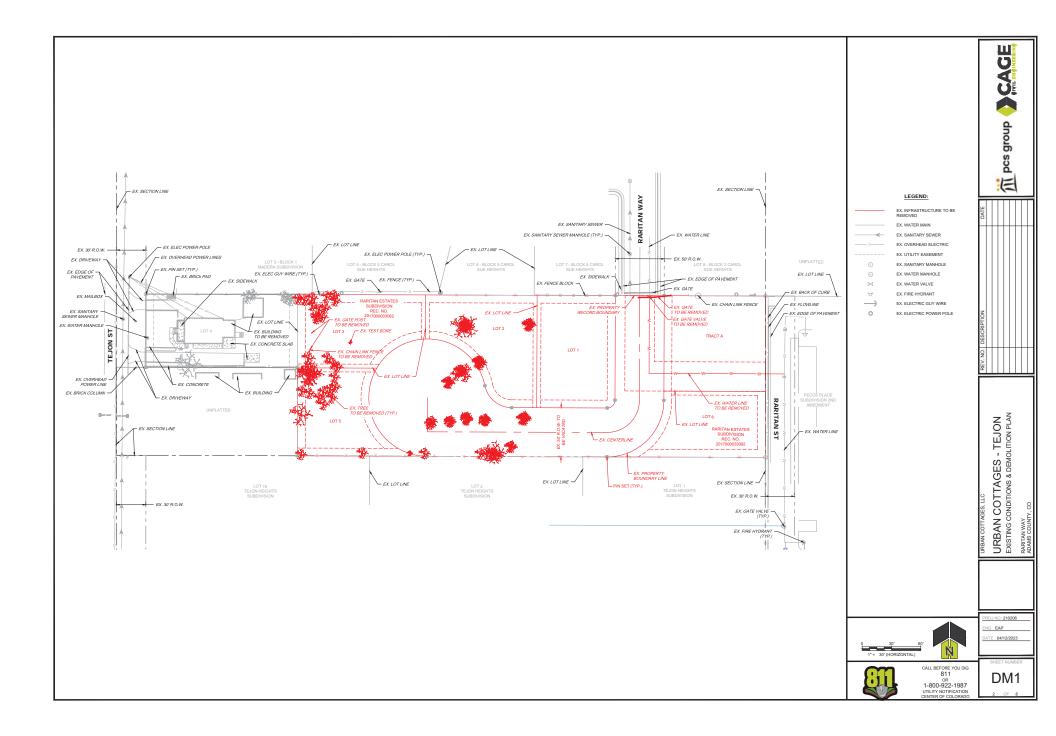

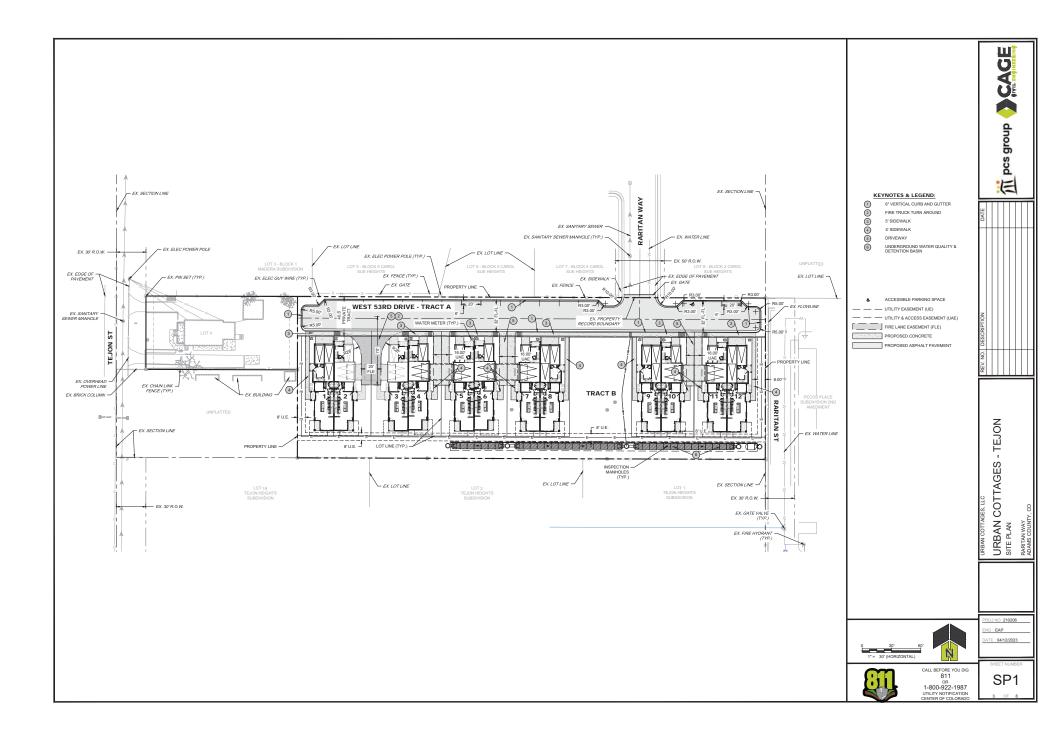

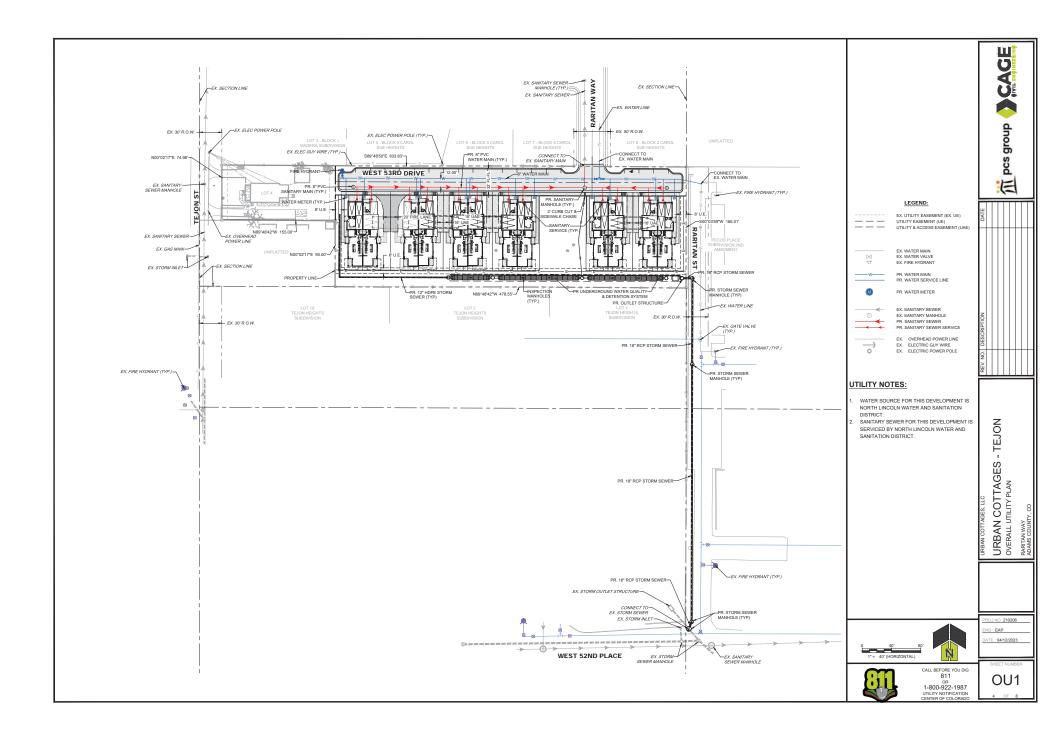


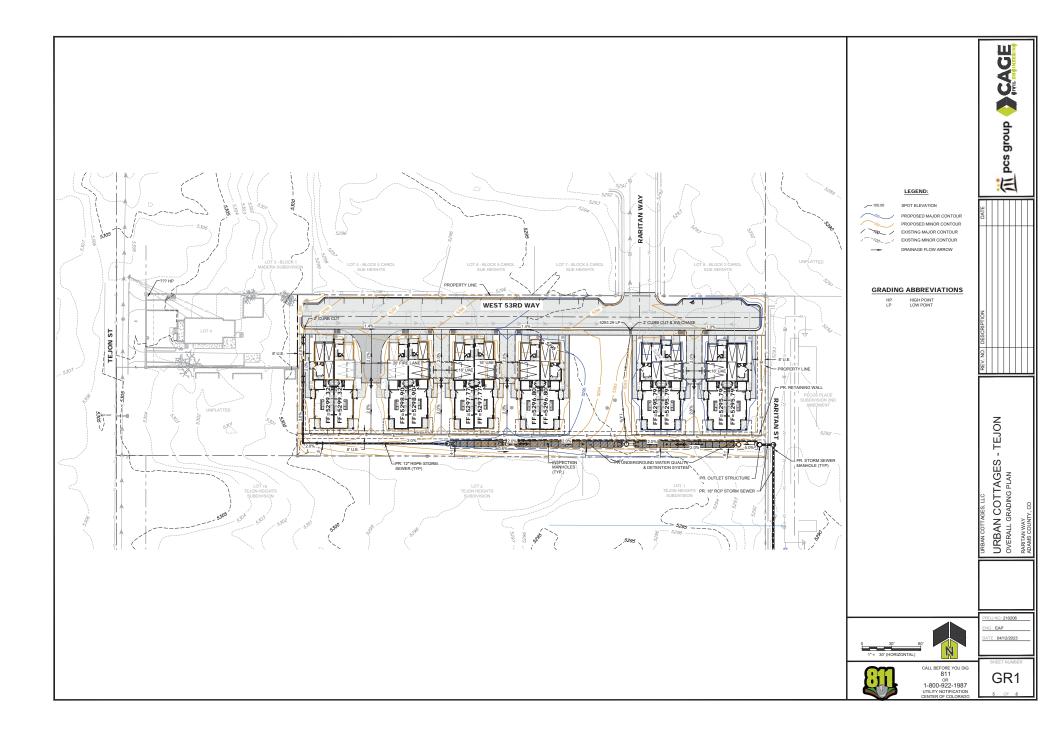

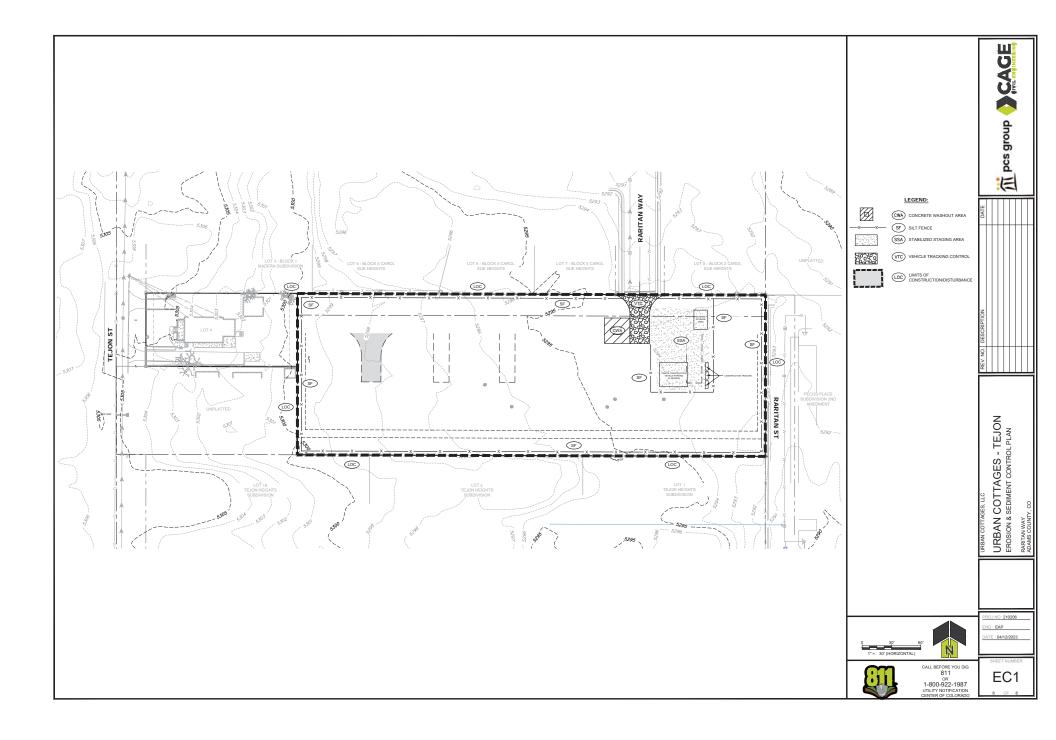

RARIT

NG : EAP

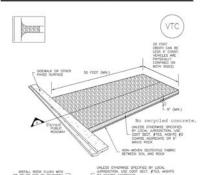

VTC-1, AGGREGATE VEHICLE TRACKING CONTROL

SM-4

VTC-3

SM-4

Urban Drainage and Flood Control District Urban Storm Drainage Criteria Manual Volume 3

675 MN SECTION A

VTC-2. AGGREGATE VEHICLE TRACKING CONTROL WITH WASH RACK

SM-6

Stabilized Staging Area (SSA)

VTC-5

STABILIZED STACING AREA MAINTENANCE NOTES

STABBLIZED STAGING AREA SHALL BE ENLANGED IF NECESSARY TO CONTAIN PARKING, STORAGE, AND UNLANDING/LOADING OPERATIONS.

VTC-3, VEHICLE TRACKING CONTROL W/ CONSTRUCTION MAT OR TURF REINFORCEMENT MAT (TRM)

Urban Drainage and Flood Control District Urban Storm Drainage Criteria Manual Volume 3

BOTE MANY JAMSDICTIONS HAVE BUT DETAILS THAT VARY FROM LOFGS STANDARD DETAILS. COMMILT WITH LOCAL JAMSDICTIONS AS TO WHICH DETAIL SHOULD BE USED WHEN DIFFERENCES AND NOTICE.

SECTION A

November 2010 Urban Drainage and Flood Control District Roy. 3/12/12 Urban Storm Drainage Criteria Manual Volume 3

VTC-4

Vehicle Tracking Control (VTC)

STABILIZED CONSTRUCTION ENTRANCE/EXIT INSTALLATION NOTES

2. CONSTRUCTION MAT OR THM STABILITED CONSTRUCTION ENFRANCES ARE ONLY TO BE LISED ON SHORT DURATION PROJECTS (THRCALLY RANGING FROM A MICK TO A MONTH) WHERE THERE WILL BE LAWRED MEDICALAR ACCESS.

3. A STABLIZED CONSTRUCTION ENTRANCE/EXIT SHALL BE LOCATED AT ALL ACCESS POINTS WHERE VEHICLES ACCESS THE CONSTRUCTION SITE FROM PAVED RIGHT-OF-WAYS. 4. STABILIZED CONSTRUCTION ENTRANCE/EXIT SHALL BE INSTALLED PRIOR TO ANY LAND DISTURBING ACTIVITIES.

5. A NON-WOVEN DESTRUCTE FABRIC SHALL BE PLACED UNDER THE STABLISED CONSTRUCTION ENTRANCE/EXIT PRICE TO THE PLACEMENT OF ROCK.

6. UNLESS OTHERWISE SPECIFED BY LOCK, JURSDICTON, ROOK SWALL CONSIST OF DOT SECT. \$703, AMBHTO \$3 COMPSE ACCREGATE OR 6" (WHUS) ROCK. Recycled concrete is not STABLIZED CONSTRUCTION ENTRANCE/DAT MAINTENANCE MOTES # #11 owed.

INSPECT BINN, EACH WORKDAY, AND MANTAIN THEM IN EFFECTIVE OPERATING CONDITION MAINTENANCE OF BINNS SHOULD BE PROJECTIVE, NOT EXCENT. RESPECT BINNS AS SOON AS POSSIBLE (AND ALMAYS WITHIN 24 HOURS) FOLLOWING A STORM THAT CAUSES SURFACE EXCENS, AND PERFORM MICESSATE MAINTENANCE.

PREQUENT OBSERVATIONS AND MANIFOLINGS AND CORRECTIVE OPERATION CONDITION. HISPECTIONS AND CORRECTIVE MEASURES SHOULD BE DOCUMENTED TRANSPORTED.

3. WHERE BMPs HAVE FALLED, REPAIR OR REPLACEMENT SHOULD BE INTIVITED UPON DISCOURTY OF THE FAILURE.

A ROCK SHALL BE REAPPLIED OR REGRADED AS NECESSARY TO THE STABLIZED ENTRANCE/EXIT TO MAINTAIN A CONSISTENT DEPTH.


5. SEDIMENT TRACKED ONTO PAVED ROADS IS TO BE REMOVED THROUGHOUT SHE DAY AND AT THE END OF THE DAY BY SHOWELING OR SWEEPING, SEDIMENT WAY NOT BE WASHED ONNO STORM FORTH FOREY.

HOTE MANY JURISDICTIONS HAVE BUP DETAILS THAT VARY FROM LIGHTED STANDARD DETAILS. COMBLIST WITH LOCAL JURISDICTIONS AS TO WHICH DETAIL SHOULD BE LISTED WHEN DETFERBLISTS AND ROTED.

(DCINES ADMITES FROM CITY OF BROSWIELD, COLORNOO, NOT HARLABLE IN AUTOCOS)

Stabilized Staging Area (SSA)

SM-6

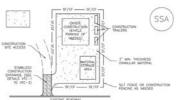

SSA-1, STABILIZED STAGING AREA

STABILIZED STAGING AREA INSTALLATION NOTES

2. STABILIZED STAGING AREA SHOULD BE APPROPRIATE FOR THE NEEDS OF THE SITE. OVERSUING RESULTS IN A LARGER AREA TO STABILIZE FOLLOWING CONSTRUCTION.

3. STAGING AREA SHALL BE STABILIZED PRIOR TO OTHER OPERATIONS ON THE SITE.

4. THE STABILIZED STACING AREA SHALL CONSIST OF A MINIMUM 3" THICK GRAVULAR MATERIAL

5. LINLESS OTHERWISE SPECIFIED BY LOCAL JURISDICTION, ROCK SHALL CONSIST OF DOT SECT. \$703, A4SHTO \$3 COARSE ACCRESATE OR 6" (MINUS) ROCK.

6. ADDITIONAL PERMETER BUP'S MAY BE REQUIRED INCLIDING BUT NOT LIMITED TO SULF FISHER AND CONSTRUCTION FISHERS. STABILIZED STADING AREA MAINTENANCE INCIDES

HSPECT BUPS EACH WORKDAY, AND MANDAM THOS IN EFFECTIVE DYEATING CONDITION
MANDENANCE OF BUPS SHOULD BE PROACTIVE, NOT REACTIVE, REFECT BUPS AS SOON AS
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GOSDON, AND PETITIONS HOSING'S AND THAT CALIFOR SUBBACK'S
GOSDON, AND PETITIONS TO SAFETY MANDENCE.

FREQUENT DESERVATIONS AND MAINTENANCE ARE NECESSARY TO MAINTAIN BURD IN EFFECTIVE OPERATING CONDITION. INSPECTIONS AND CORRECTIVE MEASURES SHOULD BE DOCUMENTED THOROUGH.

). WHERE $\theta M^{h_{0}}$ HAVE FALCD, REPART OR REPLACEMENT SHOULD BE INITIATED UPON DISCOVERY OF THE FALLINE.

4. ROCK SHALL BE REMPLIED ON REGRADED AS NECESSARY IF RUTTING OCCURS OR LINGERLYING SUBGRACE DECOMES EXPOSED.

Urban Drainage and Flood Control District Urban Stoem Drainage Criteria Manual Volume 3

November 2010 Rev. 3/12/12

Urban Drainage and Flood Control District Urban Storm Drainage Criteria Manual Volume 3

Urban Drainage and Flood Control District Urban Steem Drainage Criteria Manual Volume 3

SC-1

SC-1

SAT FENCE INSTALLATION NOTES

SAT FINCE MAINTINANCE HOTES

URBAN COTTAGES - TEJON CONSTRUCTION DETAILS - EROSION CONTROL

RARIT

OJ NO: 210206 NG : EAP

DATE: 04/12/2023

DT2

-----SLT FENCE GEOTEXTILE FLOW -



Urban Drainage and Flood Control District Urban Storm Drainage Criteria Manual Volume 3

HOTE, MANY JURSDICTIONS HAVE BUP DETAILS THAT WARY FROM LIGHTED STANDARD DETAILS. CONSULT WITH LOCAL JURSDICTIONS AS TO WHICH DETAIL SHOULD BE LISED WHEN DETERMINED AND MODERN AND TO WHICH DETAIL SHOULD BE LISED WHEN

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2. A UNIFORM θ^* X θ^* ANCHOR TRENCH SHILL BE EXCHARGE USING TRENCHER OR SILT FORCE INSTRUCTION DEVICE. NO ROBO GRACIES, SECRECE, OR SMEAR COURSENT SHILL COMPACT ANCHOR TRENCH BY HARD WITH A "JUMPING JACK" OR BY WHEEL HOLLING. COMPACTION SHALL BE SUCH THAT SLT FONCE RESISTS BEING PULLED OUT OF ANCHOR SENICH BY HARD. A SLT FONCE SHALL BE PULLED TIGHT AS IT IS ANCHORED TO THE STANES. THERE SHOULD BE NO NOTICEABLE SAG BETWEEN STANES AFTER IT HAS BEEN ANCHORED TO THE STANES.

5. SET FERCE FARROL SHALL BE ANCHORED TO THE STAKES USING 1" HEAVY SUTY STAPLES OR HALS WITH 1" HEADS, STAPLES AND HALS SHOULD BE PLACED 3" ALONG THE FARRIC DOWN THE STAKE.

E. AT THE END OF A PLIN OF SILT FONCE ALENG A CONTOUR, THE SILT FONCE SHOULD BE TURNED PERPENDICULAR TO THE CONTOUR TO CREATE A "1-HOOK." THE "1-HOOK" EXTREMOR PERPENDICULAR TO THE CONTOUR SHOULD BE OF SUFFICIENT LESSIN TO KEEP RUNOT FROM FLOWING AROUND THE END OF THE SILT FOLKE (TYPICALLY TO "- 20"). 7. SLT FENCE SHALL BE INSTALLED PRIOR TO ANY LAND DISTURBING ACTIVITIES.

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3. WHERE BMPS HAVE FALED, REPAIR OR REPLACEMENT SHOULD BE INTATED UPON DISCOVERY OF THE FALURE. 4. SEDMENT ACCUMULATED UPSTREAM OF THE SLT FENCE SHALL BE REMOVED AS NEEDED TO MANTAIN THE PUNCTIONALITY OF THE BMP, TYPICALLY WHEN DEPTH OF ACCUMULATED SEDMENTS IS APPROXIMATELY 6". S. REPAIR OR REPLACE SLT FENCE WHEN THERE ARE SIGNS OF WEAR, SUCH AS SAGGING, TEARING, OR COLLARSE. 6. SLT FENCE IS TO REMAN IN PLACE UNTIL THE UPSTREAM DISTURBED AREA IS STABLUED AND APPROVED BY THE LOCAL JURISDICTION, OR IS REPLACED BY AN EQUIVALENT PERMITER SCIMENT CONTROL DBY. 7. WHEN SLT FEMOLE'S REMOVED, ALL DISTURBED AREAS SHALL BE COVERED WITH TOPSON, SEEDED AND MULCHED OR OTHERWISE STABILIZED AS APPROVED BY LOCK, JURISDICTION.

November 2010

Concrete Washout Area (CWA)

CWA BXBMN CONCRETE WASHOUT AREA PLAN 8 X 8 WH. SECTION A

CWA-1. CONCRETE WASHOUT AREA

CWI. INSTALLATION NOTES

1. SEE PLAN VEW FOR:
-CWA INSTALLATION LOCATION.

- 3. THE CWA SHALL BE INSTALLED PRICE TO CONCRETE PLACEMENT ON SITE
- 4. CBA SHALL RICLIDE A FLAT SUBSURFACE PIT THAT IS AT LEAST B' BY B' SLOPES LEADING OUT OF THE SUBSURFACE PIT SHALL BE 31 OF FLATTER. THE PIT SHALL BE AT LEAST 3" CETP.
- 5. BOTH SURROUNDING SIDES AND BACK OF THE CHA SHALL HAVE MINIMUM HEIGHT OF 1". 6. YEHICLE TRACKING PAD SHALL BE SLOPED 2% TOWARDS THE CMA.
- 7 SIGNS SHALL BE PLACED AT THE CONSTRUCTION ENTRANCE, AT THE CBA, AND ELSCHWICKS AS INCESSANT TO CLEARLY INDICATE THE LOCATION OF THE CBA TO OPERATORS OF CONCRETE TRUCKS AND PRAIR POST.
- 8. USE EXCAVATED MATERIAL FOR PERMETER DEPM CONSTRUCTION.

Urban Drainage and Flood Control District Urban Stoem Drainage Criteria Manual Volume 3

SECTION A SF-1. SILT FENCE Urban Drainage and Flood Control District Urban Storm Drainage Criteria Manual Volume 3 Concrete Washout Area (CWA) MM-1

CWA MARKEDIANCE NOTES

MM-1

PICTECT BMP'S EACH WORNDAY, AND MAINTAIN THEM IN EFFECTIVE OPERATING COMMITTEE MAINTENANCE OF BMP'S SHOULD BE PROJECTIVE, NOT REACTIVE, NOT REACTIVE, ASSECT BMP'S SOON AS POSSIBLE, CAND AUBMIS WITHIN 24 HOURSEY FOLLOWING A STORM THAT CHAPTES SURFACE.

PREQUENT DESCRIPTIONS AND MAINTDWINCE ARE NECESSARY TO MAINTAIN BMP4 IN ECTIVE OPERATIVE CONDITION, INSPECTIONS AND CORRECTIVE MEASURES SHOULD BE JUMENTED THEOROGICALY.

A. THE CHA SHALL BE REPARED, CLEANED, OR ENLANCED AS NECESSARY TO MAINTAIN CAPACITY FOR CONCRETE MASTE, CONCRETE MATERIALS, ACCUMULATED IN PIT, SHALL BE REMOVED OF NECESTAL OF RESPONDING OF

CONCRETE WASHOUT WATER, WASTED PRICES OF CONCRETE AND ALL OTHER DEBMIS IN the SUBSUPFACE PIT SHALL BE TRANSPORTED FROM THE JOB SITE IN A WATER-TIGHT CONTAINOR AND DISPOSED OF PROPERTY.

8. THE CHA THALL REMAIN IN PLACE UNTS. ALL CONCRETE FOR THE PROJECT IS PLACED 7. WHEN THE CHA IS REMOVED, COVER THE DISTURBED AREA WITH TOP SOIL, SEED AND MULCH OR CITHERWISE STABILIZED IN A MAINER APPROVED BY THE LOCAL JURISDICTION.

DETAL MONTO FROM DOUGHD COUNTY, COLUMNIC AND THE CITY OF PARKET, COLUMNIC, NOT AMAJOSE IN AUTOCO. NOTE, MANY JURISDICTIONS HAVE BUILD DETAILS THAT WARY FROM UDICO, STANDARD DETAILS, CONSULT WITH LOCAL JURISDICTIONS AS TO WHICH DETAIL SHOULD BE USED WHEN INTERCENTED ARE NOTED.

CWA-4

Urban Drainage and Flood Control District Urban Storm Drainage Criteria Manual Volume 3

CASE NO. PRC2022-00008

LOCATED IN THE NORTHWEST QUARTER OF SECTION 16, TOWNSHIP 3 SOUTH, RANGE 68 WEST, 6TH PRINCIPAL MERIDIAN, COUNTY OF ADAMS, STATE OF COLORADO SHEET 1 OF 2

PURPOSE:

THE PURPOSE OF THIS PLAT IS TO RESUBDIVIDE LOT 1, LOT 2, LOT 3, LOT 5 TRACT A, AND RARITAN WAY RIGHT-OF-WAY OF RARITAN ESTATES SUBDIVISION RECORDED AT RECEPTION NO. 2017000033082.



DEDICATION AND OWNERSHIP CERTIFICATION:

KNOW ALL MEN BY THESE PRESENTS THAT OWNER/UC TEJON, LLC. BEING THE SOLE OWNER OF THE FOLLOWING DESCRIBED TRACT OF LAND SHOWN HEREIN, SITUATED IN THE NORTHWEST QUARTER OF SECTION 16, TOWNSHIP 3 SOUTH, RANGE 68 WEST, 6TH P.M., COUNTY OF ADAMS, STATE OF COLORADO, MORE PARTICULI RATY DESCRIBED AS FOLLOWS:

LOTS 1, 2, 3, 5, 6 AND TRACT A, RARITAN ESTATES SUBDIVISION, COUNTY OF ADAMS, STATE OF COLORADO.


CONTAINS 78,965 SQUARE FEET OR 1.813 ACRES, MORE OR LESS.

HAVE BY THESE PRESENTS LAID OUT, PLATTED AND SUBDIVIDED THE SAME INTO 12 LOTS, 1 BLOCK, AND 2 TRACTS AND EASEMENTS AS SHOWN ON THIS PLAT UNDER THE NAME AND STYLE OF RARTIAN ESTATES SUBDIVISION AMENDMENT NO. 1, AND DO HEREBY GRANT TO THE COUNTY OF ADAMS, STATE OF COLORADO, FOR THE USE OF THE PUBLIC, THE EASEMENTS AS SHOWN FOR PUBLIC UTILITIES, CABLE TV AND DETENTION POND AREAS, FLOODWAY AND FLOODPLAIN LIMITS, DRAINAGE AND OTHER PUBLIC PURPOSES AS DETERMINED BY THE COUNTY OF ADAMS.

THE UNDERSIGNED DOES HEREBY DEDICATE, GRANT AND CONVEY TO ADAMS COUNTY HOSE PUBLIC EASEMENTS (AND TRACTS) AS SHOWN ON THE PLAT; AND FURTHER RESTRICTS THE USE OF ALL PUBLIC EASEMENTS TO ADAMS COUNTY AND/OR ITS ASSIGNS, PROVIDED HOWEVER, THAT THE SOLE RIGHT AND AUTHORITY TO RELEASE OR QUITCLAIM ALL OR ANY SUCH PUBLIC EASEMENTS SHALL REMAIN EXCLUSIVELY VESTED IN ADAMS COUNTY.

EXECUTED THIS DAT OF, 2023 A.D.
OWNER: UC TEJON, LLC
CHASE STILLMAN
ACKNOWLEDGMENT
STATE OF COLORADO }
COUNTY OF
THE FOREGOING DEDICATION WAS ACKNOWLEDGED BEFORE ME THIS DAY OF 2023, BY CHASE STILLMAN AS MANAGER OF UC TEJON, LLC.
NOTARY PUBLIC

MY COMMISSION EXPIRES _____

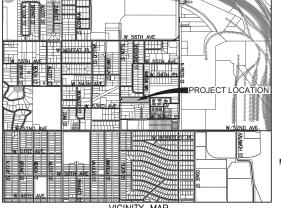

VICINITY MAP

GENERAL NOTES

- 1. NOTICE: ACCORDING TO COLORADO LAW YOU MUST COMMENCE ANY LEGAL ACTION BASED UPON ANY DEFECT IN THIS SURVEY WITHIN THREE (3) YEARS AFTER YOU FIRST DISCOVER SUCH DEFECT. IN NO EVENT MAY ANY ACTION BASED UPON ANY DEFECT IN THIS SURVEY BE COMMENCED MORE THAN TEN (10) YEARS FROM THE DATE OF THE CERTIFICATION SHOWN HEREON.
- 2. BASIS OF BEARINGS: BEARINGS SHOWN HEREON ARE BASED UPON THE NORTHERLY LINE OF RARITAN ESTATES SUBDIVISION WHICH BEARS NORTH 89'48'50" WEST, SAID LINE IS MONUMENTED AS SHOWN HEREIN.
- 3. THE LINEAL UNITS OF MEASURE SHOWN ON THIS SURVEY ARE BASED UPON THE U.S. SURVEY FOOT.
- 4. THIS SURVEY DOES NOT CONSTITUTE A TITLE SEARCH BY EMK CONSULTANTS, INC. TO DETERMINE RECORD TITLE, EASEMENTS OR RIGHTS-OF-WAY, OLD REPUBLIC NATIONAL TITLE INSURANCE COMPANY, ORDER NUMBER: IN70763176, DATED FEBRUARY 4, 2022 AT 5:00 P.M. WERE RELIED UPON FOR ALL INFORMATION REGARDING RECORD TITLE, EASEMENTS OF RECORD AND RIGHTS-OF-WAY.
- 5. THIS PLAT OF RARITAN ESTATES SUBDIVISION AMENDMENT NO.1 HEREBY VACATES ALL RIGHTS-OF-WAY AND EASEMENTS AS DEDICATED TO THE PUBLIC ON THE RARITAN ESTATES SUBDIVISION FINAL PLAT AS RECORDED AT RECEPTION NO.: 20170000033082, ON APRIL 17, 2017, IN THE PUBLIC RECORDS OF ADAMS COUNTY, COLORADO. THE 30 FOOT NORTH LINCOLN WATER AND SANITATION EASEMENT RECORDED AT RECEPTION NO. 2017000064286 AS SHOWN HEREON WILL BE VACATED BY SEPARATE DOCUMENT.
- 6. THE PRIVATE ACCESS DRIVE SHOWN HEREON AS TRACT A WILL BE MAINTAINED BY THE SUBDIVIDER, ITS (OR HIS) SUCCESSORS OR ASSIGNS, UNTIL SUCH TIME AS MAINTENANCE OF THE PRIVATE ACCESS DRIVES IS ASSUMED BY THE HOMEOWNERS ASSOCIATION. THE HOMEOWNERS ASSOCIATION SHALL BE RESPONSIBLE FOR KEEPING THE PRIVATE ACCESS DRIVE PASSABLE AT ALL TIMES. THE PRIVATE ACCESS DRIVES SHALL NOT BE ACCEPTED FOR OWNERSHIP NOR MAINTENANCE BY ADAMS COUNTY IN THE FUTURE. WITH THE SALE OF EACH LOT, THE OWNER SHALL PROVIDE THE PURCHASER(S) A NONEXCLUSIVE PERPETUAL ACCESS EASEMENT OVER, THROUGH AND ACROSS THE PRIVATE ACCESS DRIVES, AND ACROSS ANY OFFSITE PRIVATE ROADS THAT CONNECT THIS SUBDIVISION TO A PUBLIC ROAD.

CONTINUED ON NEXT SHEET

SURVEYOR'S CERTIFICATE

I, STEPHEN H. HARDING, A PROFESSIONAL LAND SURVEYOR LICENSED TO PRACTICE LAND SURVEYING IN THE STATE OF COLORADO, DO HEREBY CERTIFY THAT THERE ARE NO ROADS, PIPELINES, IRRIGATION DITCHES OR OTHER EASEMENTS IN EVIDENCE OR KNOWN BY ME TO EXIST ON OR ACROSS THE HERLINBEFORE DESCRIBED PROPERTY, EXCEPT AS SHOWN ON THIS PLAT. I FURTHER CERTIFY THE THE SURVEY WAS PERFORMED UNDER MY DIRECT RESPONSIBILITY, SUPERVISION AND CHECKING, AND THAT THIS PLAT ACCURATELY REPRESENTS SAID SURVEY, AND THAT ALM MONUMENTS EXIST AS SHOWN HEREON.

STEPHEN H. HARDING, PLS 29040 COLORADO LICENSED PROFESSIONAL LAND SURVEYOR FOR AND ON BEHALF OF EMK CONSULTANTS, INC.

RECOMMENDED FOR APPROVAL BY THE ADAMS COUNTY PLANNIN THIS DAY OF . A.	G COMMISSION D. 202 .

CLIMID		
CHAIR		

BOARD OF COUNTY COMMISSIONERS APPROVAL	
APPROVED BY ADAMS COUNTY PLANNING COMMISSION THIS	DAY OF
, 20	

BY: ______CHAIR

ADAMS COUNTY ATTORNEY'S OFFICE

APPROVED AS TO FORM

PREPARED BY

EMK CONSULTANTS, INC.

LAND DEVELOPMENT
ENGINEERING SURVEYING
7006 SOUTH ALTON WAY BLDD A
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JOB NO. 13297


RARITAN ESTATES SUBDIVISION

AMENDMENT NO. 1
DATE PREPARED: APRIL 3, 2023
PERPARED FOR:
UC TEJON, LLC
3465 SOUTH GAYLORD COURT, A304
ENGLEWOOD, COLORADO 80113
ATTN: TODD JOHNSON P.E.
SHEET 1 OF 2

RARITAN ESTATES SUBDIVISION AMENDMENT NO. 1 PRELIMINARY PLAT


CASE NO. PRC2022-00008


LOCATED IN THE NORTHWEST QUARTER OF SECTION 16, TOWNSHIP 3 SOUTH, RANGE 68 WEST, 6TH PRINCIPAL MERIDIAN, COUNTY OF ADAMS, STATE OF COLORADO

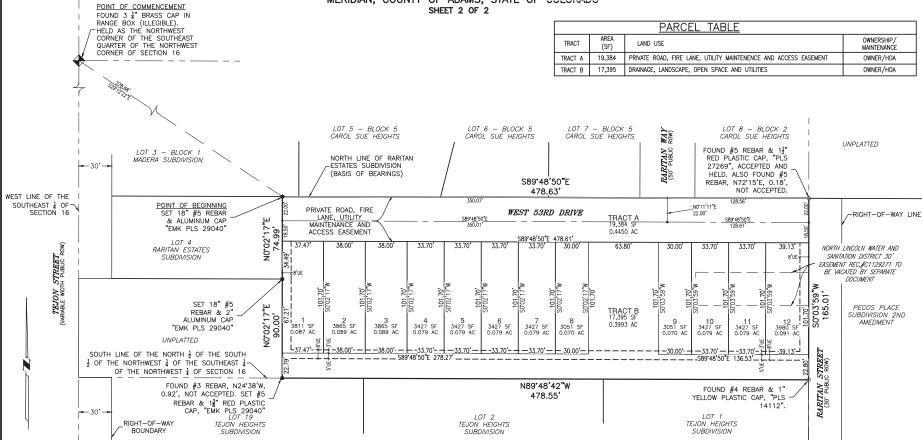

GENERAL NOTES CONTINUED

- 7. STORM DRAINAGE FACILITIES STATEMENT: THE POLICY OF THE COUNTY REQUIRES THAT MAINTENANCE ACCESS BE PROVIDED TO ALL STORM DRAINAGE FACILITIES TO ASSURE CONTINUOUS OPERATIONAL CAPABILITY OF THE SYSTEM. THE PROPERTY OWNERS SHALL BE RESPONSIBLE FOR THE MAINTENANCE OF ALL DRAINAGE FACILITIES INCLUDING INLETS, PIPES, CULVERTS, CHANNELS, DITCHES, HYDRAULIC STRUCTURES, AND DETENTION BASINS LOCATED ON THEIR LAND UNLESS MODIFIED BY THE SUBDIVISION DEVELOPMENT AGREEMENT. SHOULD THE OWNER FALL TO ADEQUATELY MAINTAIN SAID FACILITIES, THE COUNTY SHALL HAVE THE RIGHT TO ENTER SAID LAND FOR THE SOLE PURPOSE OF OPERATIONS AND MAINTENANCE. ALL SUCH MAINTENANCE COSTS WILL BE ASSESSED TO THE PROPERTY OWNERS.
- 8. EASEMENTS SHOWN HEREIN ARE DEDICATED TO ADAMS COUNTY FOR THE BENEFIT OF THE APPLICABLE UTILITY PROVIDERS FOR THE INSTALLATION, MAINTENANCE, AND REPLACEMENT OF ELECTRIC, GAS, TELEVISION, CABLE, AND TELECOMMUNICATIONS FACILITIES (DRY UTILITES). UTILITY EASEMENTS SHALL BE GRANTED WITHIN ANY ACCESS EASEMENTS AND PRIVATE STREETS IN THE SUBDIVISION. PERMANENT STRUCTURES, IMPROVEMENTS, OBJECTS, BUILDINGS, WELLS, AND OTHER OBJECTS THAT MAY INTERFERE WITH THE UTILITY FACILITIES OR USE THEREOF (INTERFERING OBJECTS) SHALL NOT BE PERMITTED WITHIN SAID UTILITY EASEMENTS AND THE UTILITY PROVIDERS, AS GRANTEES, MAY REMOVE ANY INTERFERING OBJECTS AT NO COST TO SUCH GRANTEES, INCLUDING VEGETATION. PUBLIC SERVICE COMPANY OF COLORADO (PSCO) AND ITS SUCCESSORS RESERVE THE RIGHT TO REQUIRE ADDITIONAL EASEMENTS AND TO REQUIRE THE PROPERTY OWNER TO GRANT PSCO AN EASEMENT ON ITS STANDARD FORM. WET UTILITIES (WATER, SANITARY SEWER, AND/OR STORM SEWER) SHALL CROSS DRY UTILITY EASEMENTS AT NEAR RIGHT ANGLES.
- 9. WEST 53RD DRIVE IS TO BE PRIVATELY OWNED AND MAINTAINED BY UC TEJON, LLC. AND THE HOME OWNER'S ASSOCIATION.

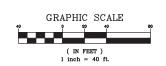

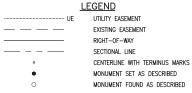



EMK CONSULTANTS, INC. LAND DEVELOPMENT ENGINEERING SURVEYING 5006 SOUTH ALTON WAY, BLDG. F CENTENNIAL, COLORADO 80112-2019 (303)694-1520 www.EMK.com

JOB NO. 13297

RARITAN ESTATES SUBDIVISION AMENDMENT NO. 1 DATE PREPARED: APRIL 3, 2023

DATE PREPARED: APRIL 3, 2023
PREPARED: FOR:
UC TEJON, LLC
3465 SOUTH GAYLORD COURT, A304
ENGLEWOOD, COLORADO 80113
ATTN: TODD JOHNSON P.E.
SHEET 2 OF 2

RARITAN ESTATES REDEVELOPMENT

A REPLAT OF LOTS 1-6 AND TRACT A, RARITAN ESTATES SUBDIVISION LOCATED IN THE NORTHWEST QUARTER OF SECTION 16, TOWNSHIP 3 SOUTH, RANGE 68 WEST,

6TH PRINCIPAL MERIDIAN COUNTY OF ADAMS, STATE OF COLORADO

PLANNED UNIT DEVELOPMENT / PRELIMINARY DEVELOPMENT PLAN

VICINITY MAP



CERTIFICATE OF OWNERSHIP

KNOW ALL MEN BY THESE PRESENTS THAT UC TEJON, LLC. BEING THE SOLE OWNER OF THE FOLLOWING DESCRIBED TRACT OF LAND SHOWN HEREIN. SITUATED IN THE NORTHWEST QUARTER OF SECTION 16, TOWNSHUP3 SOUTH, RANGE 68 WEST 6TH P.M., COUNTY OF ADAMS, STATE OF COLORADO, MORE PARTICULARLY DESCRIBED AS FOLLOWS:

LOTS 1, 2, 3, 4, 5, 6 AND TRACT A, RARITAN ESTATES SUBDIVISION, COUNTY OF ADAMS, STATE OF COLORADO.

CONTAINS 78,965 SQUARE FEET OR 1.813 ACRES, MORE OR LESS.

HAVE BY THESE PRESENTS LAID OUT, PLATTED AND SUBDIVIDED THE SAME INTO 12 LOTS 1 BLOCK AND 2 TRACTS AND FASEMENTS AS SHOWN ON THIS PLAT UNDER THE NAME AND STYLE OF RARITAN ESTATES SUBDIVISION AMENDMENT NO. 1, AND DO HEREBY GRANT TO THE COUNTY OF ADAMS, STATE OF COLORADO, FOR THE USE OF THE PUBLIC, THE EASEMENTS AS SHOWN FOR PUBLIC UTILITIES, CABLE TV, AND DETENTION POND AREAS, FLOODWAY AND FLOODPLAIN LIMITS, DRAINAGE, AND OTHER PUBLIC PURPOSES AS DETERMINED BY THE COUNTY OF ADAMS.

THE LINDERSIGNED DOES HEREBY DEDICATE GRANT AND CONVEY TO ADAMS COUNTY THOSE PUBLIC EASEMENTS (AND TRACTS) AS SHOWN ON THE PLAT; AND FIRTHER RESTRICTS THE USE OF ALL PUBLIC EASEMENTS TO ADAMS COUNTY AND/OR ITS ASSIGNS, PROVIDED HOWEVER, THAT THE SOLE RIGHT AND AUTHORITY TO RELEASE OR QUITCALM ALL OR ANY SUCH PUBLIC EASEMENTS SHALL REMAIN EXCLUSIVELY VESTED IN ADAMS COUNTY.

EXECUTED THIS	DAY OF	, 2023 A.D.
BYCHASE STILLMAN		

SHEET INDEX Sheet Number **Sheet Title COVER SHEET** NARRATIVE & STANDARDS 2 3 SITE PLAN 4 LOT TYPICAL & STREET SECTIONS PRELIMINARY LANDSCAPE, 5 **CIRCULATION & FENCING** 6 OPEN SPACE DIAGRAM ILLUSTRATIVE SITE PLAN 8 ARCHITECTURAL ELEVATIONS 9 ARCHITECTURAL ELEVATIONS 10 ARCHITECTURAL ELEVATIONS 11 ARCHITECTURAL ELEVATIONS

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REDEVELOPMENT

PLANNED UNIT DEVELOPMENT / RELIMINARY DEVELOPMENT PLAN

PRELIMINARY

STATI

RARITAN

LEGAL DESCRIPTION

LOT 4. RARITAN ESTATES SUBDIVISION, COUNTY OF ADAMS, STATE OF COLORADO

LOTS 1, 2, 3, 5, 6 AND TRACT A, RARITAN ESTATES SUBDIVISION, COUNTY OF ADAMS, STATE OF COLORADO.

PLANNING COMMISSION APPROVAL

RECOMMENDED FOR APPROVAL BY THE ADAMS COUNTY PLANNING COMMISSION THIS _____ DAY OF _____

BOARD OF COUNTY COMMISSIONS APPROVAL

APPROVED BY THE ADAMS COUNTY BOARD OF COUNTY COMMISSIONERS THIS _____ DAY OF __

ADAMS COUNTY ATTORNEY'S OFFICE

APPROVED AS TO FORM

Issue Date: 04/12/2023

REVISIONS:		DATE:
1		XX/XX/XX
2		
3		

NOT FOR CONSTRUCTION

■ Sheet Name ■ **COVER SHEET**

■ Sheet Number ■

11 of

DEVELOPER

URBAN COTTAGES, LLC 10657 E IDA AVENUE ENGLEWOOD, CO 80111 PHONE: 717.875.3961 CHASE STILLMAN

PLANNER/LANDSCAPE ARCHITECT

PCS GROUP, INC. PO BOX 18287 DENVER, CO 80126 PHONE: 303.531.4985 ALAN CUNNINGHAM

CIVIL ENGINEER

CAGE CIVIL ENGINEERING 999 18TH ST, SUITE 2110 **DENVER, CO 80202** PHONE: 720.206.6625 ERIC PEARSON

SURVEYOR

EMK CONSULTANTS, INC. 7006 SOUTH ALTON WAY, BLDG. F CENTENNIAL, CO 80112 PHONE: 303.694.1520 STEPHEN HARDING

ARCHITECT

GODDEN SUDIK 5975 S. QUEBEC ST. CENTENNIAL, CO 80111 303.455.4437 ALEX JEWETT

EXPLANATION OF THE CHARACTERISTICS OF THE PLID

THE PUD-PDP PROPOSES THE DEVELOPMENT OF 12 SINGLE FAMILY ATTACHED/ PAIRED WITH ADU RESIDENTIAL HOMES LOCATED ON SEVERAL PARCELS TOTALING APPROXIMATELY 1.81 ACRES. THE SITE CONSISTS OF PREDOMINANTLY VACANT LINDEVELOPED LAND. PROPOSED RESIDENTIAL LOTS WILL BE A MIN. OF 2,960 SF. IN AREA. THE PROJECT WILL INCLUDE PASSIVE AND ACTIVE LANDSCAPED AREAS AND PRIVATE DRIVES. PRIMARY SITE ACCESS WILL BE PROVIDED WITH PROPOSED PRIVATE DRIVE CONNECTIONS TO RARITAN WAY, HOMES WILL BE REAR-LOADED WITH GARAGE ACCESS TO ALLEYS. HOMES WILL FRONT THE MAIN INTERNAL DRIVE (W. 53RD DR). INTERNAL WALKS WILL PROVIDED PEDESTRIAN MOVEMENT TO FRONT DOORS, ACTIVE OPEN SPACE AND ADJACENT PUBLIC STREETS.

THE ABUTTING NEIGHBORHOODS TO THE NORTH, WEST AND SOUTH ARE ZONED R-1-C. THE NEIGHBORHOOD TO THE EAST IS ZONED R-3

POTENTIAL IMPACT ON THE SURROUNDING AREA

THE PROPOSED DEVELOPMENT IS CONSISTENT WITH THE ADAMS COUNTY 2012 UPDATE TO THE COMPREHENSIVE PLAN. PROPOSED HOME MASSING, HEIGHT LIMITS AND EXTERIOR ARCHITECTURE WILL BE COMPLIMENTARY TO EXISTING ADJACENT RESIDENCES. PEDESTRIAN CONNECTIONS WILL PROVIDE GREATER ACCESS TO THE REST OF THE COMMUNITY, EXISTING UTILITY AND INFRASTRUCTURE HAS CAPACITY TO ACCOMMODATE THE DEVELOPMENT.

CONTEMPLATED DENSITIES AND LAND COVERAGE

THIS PDP-PUD CONSISTS OF 12 DWELLING UNITS WHICH A PROVIDE A DENSITY OF 6.6 DU/AC. RESIDENTIAL LOTS WILL ACCOUNT FOR 53% OF THE SITE. OPEN AREAS SUCH AS ALLEYS, ACCESS DRIVES AND COMMON OPEN SPACE AREAS WILL MAKE UP 47% OF THE SITE.

CIRCULATION AND ROAD PATTERNS

A 24' PRIVATE DRIVE (W. 53RD DR.) WILL PROVIDE INTERNAL ACCESS. THIS DRIVE WILL DEAD END AT THE WESTERN/ EASTERN EDGES OF THE PROPERTY, ALLEYS WILL BE 16' IN WIDTH AND PROVIDE GARAGE ACCESS TO MAJROITY OF UNITS WITH SIDE ACCESS. SOME UNITS WILL ACCESS FROM THE MAINDRIVE (W. 53RD DR.).

OWNERSHIP AND MAINTENANCE OF COMMON AREAS

THE HOA IS RESPONSIBLE FOR THE ENFORCEMENT OF LANDSCAPE MAINTENANCE REQUIREMENTS ASSOCIATED WITH PRIVATE OPEN SPACE TRACTS, COMMON AREAS AND MAINTENANCE OF ALL PRIVATE DRIVES, HOA RESPONSIBILITIES WITHIN THE PRIVATE DRIVES INCLUDE MAINTENANCE OF THE PAVEMENT AND CURB AND GUTTER, INCLUDING BUT NOT LIMITED TO THE REMOVAL OF GRAFFITI, SNOW, ICE, SLEET, DEBRIS OR OTHER OBSTRUCTIONS WITHIN

LOCATION AND TYPES OF LANDSCAPE MAINTENANCE PROVISIONS

THE PROJECT WILL INCLUDE PRIVATE DRIVES & ALLEYS, PRIVATE OPEN SPACE TRACTS WITH ACTIVE & PASSIVE USE AND ON-LOT RESIDENTIAL LANDSCAPE AREAS. INSTALLATION OF LANDSCAPE TRACTS AND THEIR AMMENITIES SHALL BE THE RESPONSIBILITY OF THE DEVELOPER/HOME BUILDER. MAINTENANCE OF THE TRACTS AND AMMENITIES SHALL BE THE RESPONSIBILITY OF THE HOA. THIS SHALL INCLUDE TRASH COLLECTION AND SNOW REMOVAL FRONT YARD LANDSCAPING OF RESIDENCES SHALL BE INSTALLED BY THE DEVELOPER/HOME BUILDER. RESIDENTIAL FRONT YARDS WILL FRONT THE MAIN INTERNAL DRIVE. RESIDENTIAL LOTS WILL ALSO INCLUDE PRIVATE, FENCED SIDE YARDS. SHARED USE AREAS WILL BE PROVIDED WITHIN THE MAJORITY LOTS ALLOWING ADDITIONAL OUTDOOR USABLE AREAS IN SIDE YARDS. LANDSCAPE INSTALLATION AND MAINTENANCE OF FRONT YARD LANDSCAPING SHALL BE THE RESPONSIBILITY OF THE HOME/BUILDER DEVELOPER. RESIDENTIAL FRONT YARD TYPICALS ARE INCLUDED WITH THIS PDP/PUD. RESIDENTIAL SIDE YARDS AND LANDSCAPE ADJACENT TO ALLEYS SHALL BE INSTALLED AND MAINTAINED BY THE HOMFOWNER

SERVICE PROVIDERS

- NORTH LINCOLN WATER AND SANITATION DISTRICT
- XCEL ENERGY GAS & ELECTRIC SERVICE
- COMCAST/XFINITY ADAMS COUNTY FIRE RESCUE

COVENANTS TO BE IMPOSED ON THE PUID

COVENANTS, CONDITIONS AND RESTRICTIONS (CC&R'S) SHALL BE IMPOSED ON THIS PUD AND WILL BE ENFORCED BY AN HOA ESTABLISHED WITH THIS DEVELOPMENT.

ARCHITECTURE

THESE HOMES CONSIST OF FOUR TWO-STORY PLANS THAT RANGE IN SIZE FROM 890 TO 1,850 SQUARE FEET AND BOAST CONTEMPORARY AND MOUNTAIN MODERN ELEVATION STYLES. THE HOMES ARE DESIGNED AS ALLEY LOAD AND SIDE LOADED PRODUCT THAT FEATURE FULL FRONT PORCHES AND OPEN FLOOR PLANS. WITH ALLEY AND SIDE LOADED GARAGES, THE FRONT ELEVATIONS ARE MORE ATTRACTIVE AND OPEN UP TO A GREEN SPACE. WITH LARGER COVERED FRONT PORCHES AND SMALL COVERED SIDE PORCHES, THE OUTDOOR LIVING IS MAXIMIZED ON THESE SMALLER LOTS. BUYERS CAN CHOOSE TO HAVE A LARGER FRONT PORCH TO ADD EVEN MORE OUTDOOR LIVING.

ADDITIONAL CONTROLS SUCH AS ARCHITECTURAL CONTROL COMMITTEE OF A HOMEOWNERS ASSOCIATION

NONE AT THIS TIME

SIGNAGE NONE AT THIS TIME

ACCESSORY STRUCTURES

ACCESSORY STRUCTURES ARE NOT PERMITTED.

FENCING SHALL BE PERMITTED BETWEEN LOTS AS DEPICTED IN THIS DOCUMENT. FENCING LOCATIONS AND TYPES HAVE BEEN PROVIDED WITH THIS PUD-PDP. FINAL LOCATIONS SHALL BE

ESTIMATED TIMETABLE FOR CONSTRUCTION & PHASING

THE PROJECT SHALL BE COMPLETED IN A SINGLE PHASE WITH AN ESTIMATED TIME OF CONSTRUCTION COMMENCING IN 2023.

DEFINITIONS

ALLEY LOADED GARAGE: A GARAGE WITH THE VEHICULAR DOOR ACCESS LOCATED ONTO AN ALLEY LOCATED AT THE SIDE (OR SOMETIMES FRONT) OF THE LOT.

EASEMENT GRANTOR: THE LOT OWNER GRANTING SIDE YARD AREA TO ADJACENT LOT

EASEMENT GRANTEE: THE LOT OWNER GAINING SIDE YARD AREA FROM ADJACENT LOT

PROVISIONS FOR PARKING

A MINIMUM OF TWO OFF-STREET RESIDENTIAL GARAGE PARKING SPACES WILL BE PROVIDED WITHIN EACH HOME PARALLEL SPACES ARE PROVIDED ALONG RARITAN WAY PARKING WILL NOT BE PERMITTED WITHIN THE ALLEYS AND SHALL BE SIGNED AS SUCH. A MINIMUM 35% (6 SPOTS) OF THE PROPOSED 17 PARALLEL PARKING SPOTS WILL BE DESIGNATED TOWARDS VISITOR PARKING.

O. BULK & DIMENSION STANDARDS

MIN. LOT SIZE	2,400 SF.
MIN. LOT WIDTH	32'
MANY DUBLIDING LIFECUT (2 CTODIFC)	201
MAX. BUILDING HEIGHT (2-STORIES)	35'
MINIMUM SETBACKS	
BUILDING TO FRONT LOT LINE	5'-0"
BUILDING TO ALLEY FLOW LINE	5'-0"
BUILDING SIDE TO ALLEY/PRIVATE DRIVE FLOWLINE	10'-0"
BUILDING SIDE TO LOT LINE	5'-0"
BUILDING TO BUILDING	10'-0"

PERMITTED SETRACK ENCROACHMENTS

T EXMITTED DETENDING ENOUGH TO THE ENTE		
EAVES, OVERHANGS, BAY WINDOWS	1'-0"	
WINDOW WELLS, COUNTERFORTS	2'-0"	
EXTERIOR SIDING, VENEER, BRICK, STONE	0'-4"	

UN	ıΤ	00	110
UIV	ш	CU	UI

PARKING SUMMARY		
GARAGE PARKING (2 SPACES PER UNIT)	1	36 SPACES
GUEST SPACES (PARALLEL SPACES)		17 SPACES
	TOTAL	E2 CDACEC

LANDSCAPING

RIGHT OF WAY AND OPEN SPACE LANDSCAPING SHALL BE PROVIDED IN ACCORDANCE WITH COUNTY ZONING DISTRICT REGULATIONS. ON-LOT RESIDENTIAL LANDSCAPING SHALL BE

12 UNITS

SINGLE FAMILY, ATTACHED RESIDE	ENTIAL LANDSCAPE STAND	ARDS
LOCATION	MIN. TREES	"MIN. SHRUBS
FRONT SETBACK	N/A	2
FRONT SETBACK (FRONT FACING GARAGE)	N/A	N/A***
REAR SETBACK	N/A	2
SIDE SETBACK (INTERNAL LOTS)	1	11"
SIDE SEBACK (FRONT FACING GARAGES)	N/A	11*
NOTES:		
* 1 TREE MAY BE SUBSTITUTED FOR 5 SHRUBS AT A RATE	OF 5 SHRUBS PER 1 REQUI	RED TREE.
** SHRUBS MAY BE SUBSTITUTED WITH ORNAMENTAL GRA	SSES AT A RATE OF 3 GRAS	SSES PER REQUIRED SHRUI
*** WITH FRONT FACING GARAGE LOTS, SHRUBS WILL NOT DRIVEWAY ACCESS.	BE PROVIDED WITHIN FRO	NT SETBACK DUE TO

. PLANT SIZES, TYPES AND SPECIES SHALL CONFORM TO COUNTY PERFORMANCE STANDARDS 2. A MINIMUM 30% OF THE REQUIRED FRONT AND SIDE LANDSCAPE ARE MUST BE COVERED BY LIVING GROUND MATERIAL PER COUNTY ZONING DISTRICT REGULATIONS

URB[#]N COTTAGES

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REDEVELOPMENT

ESTATE

RARITAN

PLANNED UNIT DEVELOPMENT / PRELIMINARY DEVELOPMENT PLAN

Issue Date: 04/12/2023

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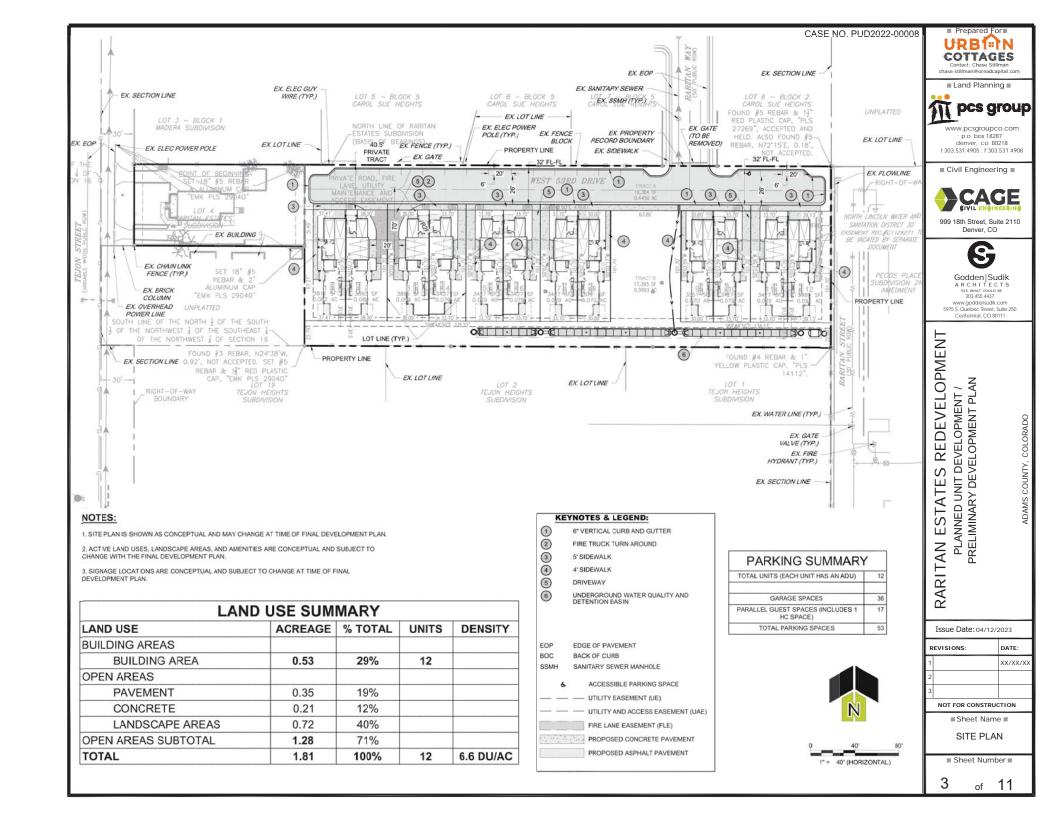
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of

11



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ADAMS COUNTY, COLORADO

RARITAN ESTATES REDEVELOPMENT PLANNED UNIT DEVELOPMENT / PRELIMINARY DEVELOPMENT PLAN

Issue Date: 04/12/2023


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PLANNED UNIT DEVELOPMENT / PRELIMINARY DEVELOPMENT PLAN

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CIRCULATION & FENCING


■ Sheet Number ■

LAND USE SUMMARY

LAND USE	ACRE AGE	% TOTAL	UNITS	DENSITY (DU/AC)
BUILDING AREAS				
RESIDENTIAL LOTS	0.53	29%	12	6.6
OPEN AREAS				
TRACT A	0.45	25%		
TRACT B	0.40	22%		
RESIDENTIAL LOTS	0.43	24%		
OPEN AREAS SUBTOTAL	1.28	71%		
TOTAL	1.81	100%	12	6.6

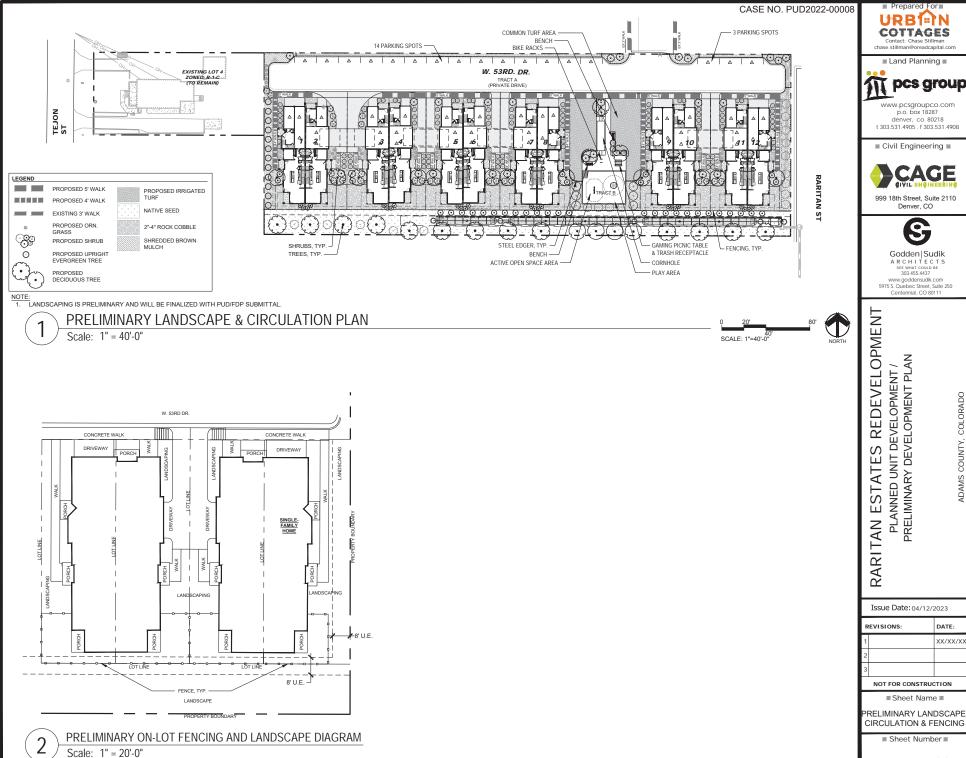OPEN SPACE TABULATIONS				
SITE AREA (AC.)		1.81		
SYMBOL	OPEN AREA TRACTS	AREA (AC.)	TOTAL REQUIRED OPEN SPACE (MIN 30%)	TOTAL PROVIDED OPEN SPACE (MIN. 30%)
	TRACT A (PRIVATE ROAD, FIRE LANE, UTIL/MAINT/ACCESS ESMT.)	0.45		
	TRACT B (DRAINAGE, LANDSCAPE, OPEN SPACE AND UTILITIES)	0.40		
	SUBTOTAL	0.85	1.81 AC X 30% =0.54 AC	0.85 AC / 1.81 AC = 47%
SYMBOL	ACTIVE OPEN SPACE USE AREAS	ACTIVE USE AREA (AC.)	TOTAL REQUIRED ACTIVE OPEN SPACE (25% OF THE <u>REQUIRED</u> OPEN SPACE)	TOTAL PROVIDED ACTIVE OPEN SPACE (NO MORE THAN 50% OF PROVIDED OPEN SPACE)
[]]	PLAY AREA , CORNHOLE COURTS, PICNIC AREA & EXERCISE EQUIPMENT STATIONS	0.15	0.54 AC X 25% = 0.14 AC	0.15 AC

NOTE: OPEN SPACE CALCULATIONS ARE BASED UPON COUNTY REQUIREMENT STATED IN:
3.3043-5.08 CALCULATION OF OPEN SPACE AREA. THE CALCULATION OF OPEN SPACE AREA SHALL INCLUDE ALL COMMON PUBLIC OR PRIVATELY HELD OPEN SPACE AREAS, ALL PROVISIONS FOR THE RIGHT-OF-WAY FOR PUBLIC ROADS AND
THE EASEMENT WIDTH FOR PRIVATE ROADS, STORM WATER FACILITIES, RECREATIONAL AREAS, TRAIL S AND GREENWAYS, INDIVIDUAL PRIVATE RESIDENTIAL OR COMMERCIAL LOT AREAS SHALL NOT BE INCLUDED IN THE OPEN SPACE
CALCULATION UNLESS THE OPEN SPACE AREAS LOCATED ON PRIVATE LOTS ARE SUBJECT TO OPEN SPACE EASEMENTS AND RESTRICTIONS.

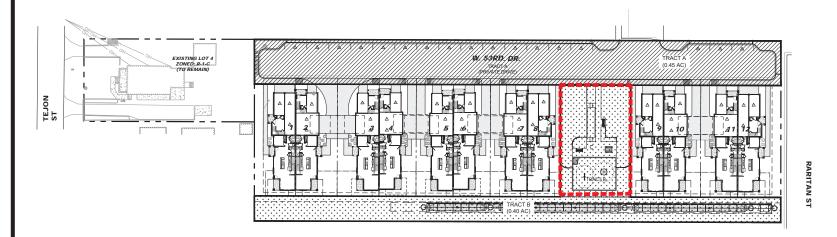

ACTIVE AND OPEN SPACE PLAN

Scale: 1"=40'-0"





■ Prepared For URB[#]N COTTAGES Contact: Chase Stillman chase.stillman@oreadcapital.com

■ Land Planning ■



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RARITAN ESTATES REDEVELOPMENT PLANNED UNIT DEVELOPMENT / PRELIMINARY DEVELOPMENT PLAN

Issue Date: 04/12/2023

DATE:
XX/XX/XX

NOT FOR CONSTRUCTION

■ Sheet Name ■

OPEN SPACE DIAGRAM

■ Sheet Number ■

(8) UNDERGROUND DETENTION

■ Land Planning ■

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RARITAN ESTATES REDEVELOPMENT PLANNED UNIT DEVELOPMENT / PRELIMINARY DEVELOPMENT PLAN

Issue Date: 04/12/2022

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NOT FOR CONSTRUCTION

■ Sheet Name ■ **ILLUSTRATIVE** SITE PLAN

■ Sheet Number ■

11 of

SITE PLAN LEGEND

(1) MAIL KIOSK

(7) MULTI-USE TURF AREA

2 BENCH

(3) CORNHOLE COURT


9 PARALLEL PARKING STALLS (17 STALLS)

(4) BIKE RACKS

5 PLAY AREA


6 PICNIC TABLE & TRASH RECEPTACLE

NOTE:
SITE PLAN IS PRELIMINARY AND SUBJECT TO CHANGE PENDING FINAL DEVELOPMENT PLAN.

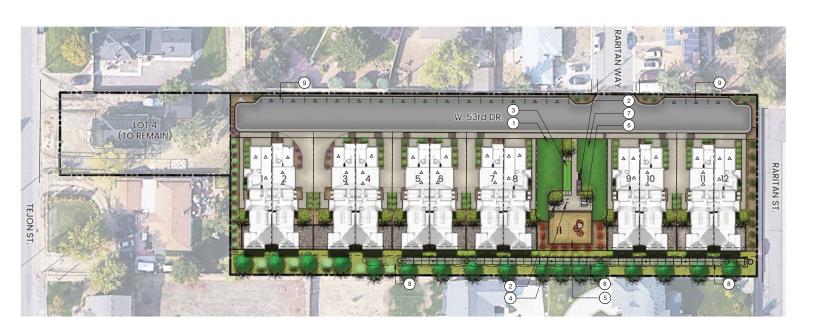

ILLUSTRATIVE SITE PLAN

Scale: 1"=40'-0"

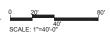





4" LAP SIDING AND TRIM: MANUF: SHERWIN WILLIAMS, OR SIM. COLOR: SAGE GREEN LIGHT (SW 2851)

8" LAP SIDING AND TRIM/FASCIA; MANUF: SHERWIN WILLIAMS, OR SIM COLOR: OAT MILK (SW 9501)

FRONT DOOR: MANUF: SHERWIN WILLIAMS, OR SIM. COLOR: KENDAL GREEN (SW 6467)

ROOF (SHINGLE): MANUF: GAF, OR SIM. COLOR: TIMBERLINE CHARCOAL

STONE: MANUF: CULTURED STONE, OR SIM. COLOR: COBBLEFIELD - GRAY

"ALL COLOR INFORMATION IS APPROXIMATE, MANUFACTURER AND FINAL TINT SUBJECT TO CHANGE

URBIEN COTTAGES

Contact: Chase Stillman chase.stillman@oreadcapital.com

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REDEVELOPMENT

PLANNED UNIT DEVELOPMENT / PRELIMINARY DEVELOPMENT PLAN **ESTATES** RARITAN

Issue Date: 04/12/2023

	133de Date: 04/ 12/2023	
R	EVISIONS:	DATE:
1		XX/XX/XX

NOT FOR CONSTRUCTION

■ Sheet Name ■

1-2 A ELEVATIONS

■ Sheet Number ■

11 of



1-2 RIGHT ELEVATION A



1-2 REAR ELEVATION A



1-2 FRONT ELEVATION A



UNIT 2

1-2 LEFT ELEVATION A

1/8" = 1'-0"

chase.stillman@oreadcapital.com

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REDEVELOPMENT PLANNED UNIT DEVELOPMENT / PRELIMINARY DEVELOPMENT PLAN

COLORADO

ESTATES RARITAN

Issue Date: 04/12/2023

R	EVISIONS:	DATE:
1		XX/XX/XX
2		
3		

NOT FOR CONSTRUCTION

■ Sheet Name ■

1-2 B ELEVATIONS

■ Sheet Number ■

of



1-2 RIGHT ELEVATION B

UNIT 1

2

1/8" = 1'-0"



1-2 REAR ELEVATION B 3 1/8" = 1'-0"



1-2 FRONT ELEVATION B 2 1/8" = 1'-0"



1-2 LEFT ELEVATION B

1/8" = 1'-0"

4" LAP SIDING AND TRIM: MANUF: SHERWIN WILLIAMS, OR SIM COLOR: SAGE GREEN LIGHT (SW 2851)

8" LAP SIDING AND TRIMFASCIA: MANUF: SHERWIN WILLIAMS, OR SIM COLOR: OAT MILK (SW 9501)

FRONT DOOR:
MANUF: SHERWIN WILLIAMS, OR SIM.
COLOR: KENDAL GREEN (SW 6467)

ROOF (SHINGLE):
MANUF: GAF. OR SIM.
COLOR: TIMBERLINE CHARCOAL

5 STONE: MANUF: CULTURED STONE, OR SIM. COLOR: COBBLEFIELD - GRAY

*ALL COLOR INFORMATION IS APPROXIMATE. MANUFACTURER AND FINAL TINT SUBJECT TO CHANGE

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REDEVELOPMENT PLANNED UNIT DEVELOPMENT / PRELIMINARY DEVELOPMENT PLAN RARITAN ESTATES

COLORADO

Issue Date: 04/12/2023 DATE: REVISIONS: XX/XX/X

NOT FOR CONSTRUCTION

■ Sheet Name ■

1-1 A ELEVATIONS

■ Sheet Number ■

of



UNIT 1

1-1 RIGHT ELEVATION A



1-1 REAR ELEVATION A 1/8" = 1'-0"

1-1 FRONT ELEVATION A



1-1 LEFT ELEVATION A

ELEVATION B MATERIAL LEGEND*

VERTICAL SIDING AND TRIMFASCIA: MANUF: SHERWIN W LLIAMS, OR SIM. COLOR: CYBERSPACE (SW 7076)

8" LAP SIDING AND TRIM: MANUF: SHERWIN WILLIAMS, OR SIM. COLOR: GRAY SCREEN (SW 1071)

FRONT DOOR: MANUF: SHERWIN WILLIAMS, OR SIM. COLOR: LEAP FROG (SW 6431)

MANUF: CULTURED STONE, OR SIM. COLOR: COUNTRY LEDGESTONE - WHEATON

ROOF (SHINGLE): MANUF: GAF, OR SIM COLOR: TIMBERLINE CHARCOAL

*ALL COLOR INFORMATION IS APPROXIMATE. MANUFACTURER AND FINAL TINT SUBJECT TO CHANGE

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REDEVELOPMENT PLANNED UNIT DEVELOPMENT / PRELIMINARY DEVELOPMENT PLAN **ESTATES**

COLORADO

RARITAN

Issue Date: 04/12/2023

R	EVISIONS:	DATE:
1		XX/XX/XX
2		
3		

NOT FOR CONSTRUCTION

■ Sheet Name ■

1-1 B ELEVATIONS

■ Sheet Number ■

of



UNIT 1

1-1 RIGHT ELEVATION B



3 1-1 REAR ELEVATION B



1-1 FRONT ELEVATION B 1/8" = 1'-0"



UNIT 1

1-1 LEFT ELEVATION B

RARITAN ESTATES REDEVELOPMENT

A REPLAT OF LOTS 1-6 AND TRACT A. RARITAN ESTATES SUBDIVISION LOCATED IN THE NORTHWEST QUARTER OF SECTION 16, TOWNSHIP 3 SOUTH, RANGE 68 WEST, 6TH PRINCIPAL MERIDIAN

COUNTY OF ADAMS, STATE OF COLORADO ZONE MAP AMENDMENT

VICINITY MAP




LEGAL DESCRIPTION

PARCEL A: LOT 4, RARITAN ESTATES SUBDIVISION, COUNTY OF ADAMS, STATE OF COLORADO.


SHEET INDEX

1 OF 3	REZONING MAP AMENDMENT
2 OF 3	SITE PLAN
3 OF 3	ILLUSTRATIVE SITE PLAN

EXISTING ZONING MAP

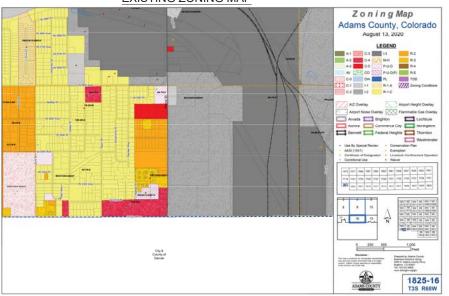

PROPOSED ZONING MAP AMENDMENT

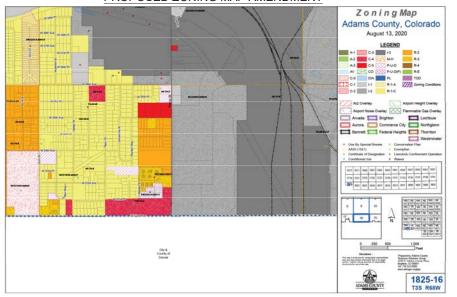



PROJECT NO. PRC2022-0008

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Denver, CO

REDEVELOPMENT ZONE MAP AMENDMENT ESTATE RARITAN

Issue Date: 04/12/2023

Issue For: 3RD SUBMITTAL

DATE:

■ Sheet Name ■

REZONING MAP **AMENDMENT**

■ Sheet Number ■

PROJECT NO. PRC2022-0008

A REPLAT OF LOTS 1-6 AND TRACT A. RARITAN ESTATES SUBDIVISION LOCATED IN THE NORTHWEST QUARTER OF SECTION 16, TOWNSHIP 3 SOUTH, RANGE 68 WEST, 6TH PRINCIPAL MERIDIAN COUNTY OF ADAMS, STATE OF COLORADO ZONE MAP AMENDMENT

URBEN COTTAGES

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REDEVELOPMENT ZONE MAP AMENDMENT STATI ш RARITAN

Issue Date: 04/12/2023

Issue For: 3RD SUBMITTAL

R	EVISIONS:	DATE:
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2		
3		
1		

■ Sheet Name ■

SITE PLAN

■ Sheet Number ■

3 of

ZONING SUMMARY

Scale: 1"=40'-0"

EXISTING ZONING (RARITAN ESTATES SUBDIVISION)	TOTAL AREA (AC.)	EXISTING ZONING	PROPOSED ZONING		
LOT 4	0.27				
LOT 1					
LOT 2					
		R-1-C	PUD		
LOT 3	1.21	1.21			
LOT 5					
TRACT A					
EXISTING RARITAN WAY RIGHT OF WAY TO BE VACATED	0.60	N/A	(PROPERTY TO BE REPLATTED)		
TOTAL SITE AREA	2.08				

LAND USE SUMMARY

PROPOSED AREA TAKEOFFS				
LAND USE	ACRE AGE	% TOTAL	UNITS	DENSITY (DU/AC)
BUILDING AREAS				
RESIDENTIAL LOTS	0.96	53%	12	6.6
OPEN AREAS				
TRACT A	0.45	17%		
TRACT B	0.40	22%		
OPEN AREAS SUBTOTAL	0.85	47%		
TOTAL	1.81	100%	12	6.6

PARKING SUMMARY TOTAL UNITS

GARAGE SPACES (2 PER UNIT)

PARALLEL GUEST SPACES (INCLUDES 1 HC SPACE)


TOTAL PARKING SPACES 53

12

36

SCALE: 1"=40'-0"

BUILDING AREAS RESIDENTIAL LOTS	0.96			
RESIDENTIAL LOTS	0.00			
	0.96	53%	12	6.6
OPEN AREAS				
TRACT A	0.45	17%		
TRACT B	0.40	22%		
DPEN AREAS SUBTOTAL	0.85	47%		
TOTAL	1.81	100%	12	6.6

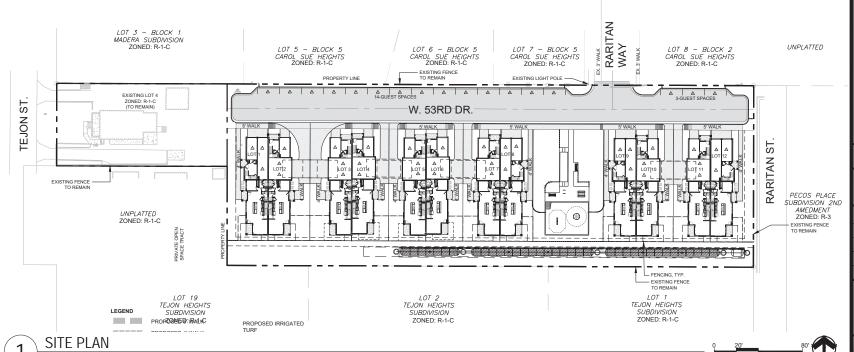

PROJECT NO. PRC2022-0008

A REPLAT OF LOTS 1-6 AND TRACT A, RARITAN ESTATES SUBDIVISION LOCATED IN THE NORTHWEST QUARTER OF SECTION 16, TOWNSHIP 3 SOUTH, RANGE 68 WEST, 6TH PRINCIPAL MERIDIAN COUNTY OF ADAMS, STATE OF COLORADO ZONE MAP AMENDMENT

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REDEVELOPMENT ZONE MAP AMENDMENT

ESTATES

RARITAN Issue Date:

04/12/2023 Issue For:

3RD SUBMITTAL

REVISIONS:		DATE:
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■ Sheet Name ■

ILLUSTRATIVE SITE PLAN

■ Sheet Number ■


3 of

SCALE: 1"=40'-0"

SITE PLAN LEGEND

- (1) MAIL KIOSK
- (7) MULTI-USE TURF AREA
- 2 BENCH
- (8) UNDERGROUND DETENTION
- (3) CORNHOLE COURT
- 9 PARALLEL PARKING STALLS
- (4) BIKE RACKS
- 5 PLAY AREA
- 6 PICNIC TABLE & TRASH RECEPTACLE

NOTE:
SITE PLAN IS PRELIMINARY AND SUBJECT TO CHANGE PENDING FINAL DEVELOPMENT PLAN.

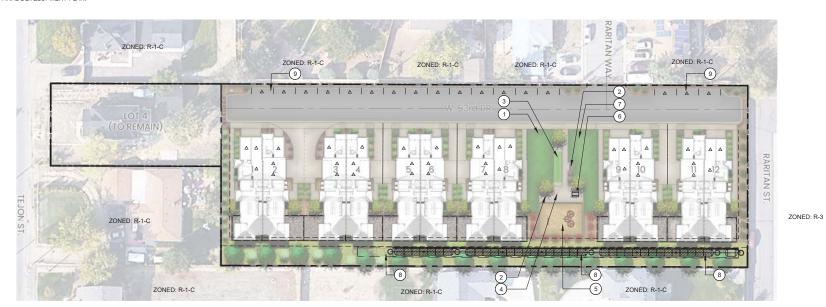

ILLUSTRATIVE SITE PLAN

Scale: 1"=40'-0"



URBAN COTTAGES – TEJON STREET PRELIMINARY DRAINAGE REPORT

LOTS 1-6, RARITAN ESTATES SUBDIVISION

ADAMS COUNTY, COLORADO

APRIL 2023

Prepared For: Urban Cottages, LLC 10657 East Ida Avenue Englewood, CO 80111

By:

CAGE Civil Engineering 405 Urban Street, Suite 404 Lakewood, CO 80228 Contact: Eric Pearson

Phone: 720-206-6625

URBAN COTTAGES – TEJON STREET LEVEL 2 STORM DRAINAGE REPORT Page i of iii

ENGINEER'S CERTIFICATION:

I hereby affirm that this report (plan) for the preliminary drainage design of Urban Cottages – Tejon Street was prepared by me (or under my direct supervision) in accordance with the provisions of the Adams County Storm Drainage Design and Stormwater Quality Regulations for the owners thereof. I understand that Adams County does not and will not assume liability for drainage facilities designed by others.

Eric Pearson, PE	Date
State of Colorado No. 45415	
For and on behalf of CAGE Civil Engineering	

DEVELOPER'S CERTIFICATION:

Urban Cottages, LLC hereby certifies that the drainage facilities for Urban Cottages – Tejon Street shall be constructed according to the design presented in this report. I understand that Adams County does not and will not assume liability for the drainage facilities designed and/or certified by my engineer. I understand that Adams County reviews drainage plans pursuant to Colorado Revised Statues Title 30, Article 28; but cannot on behalf of Urban Cottages, LLC, guarantee that final drainage design review will absolve Urban Cottages, LLC and/or their successors and/or assigns the future liability for improper design. I further understand that approval of the Final Plant and/or Final Development Plan does not imply approval of my engineer's drainage design.

Date	
Name of Developer	



URBAN COTTAGES - TEJON STREET

LEVEL 2 STORM DRAINAGE REPORT

Page ii of iii

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URBAN COTTAGES – TEJON STREET LEVEL 2 STORM DRAINAGE REPORT Page iii of iii

APPENDICES

- A. Maps and Exhibits
- B. Hydrologic Computations
- C. Hydraulic Computations
- D. Referenced Materials



URBAN COTTAGES – TEJON STREET PRELIMINARY DRAINAGE REPORT Page 1 of 4

A. GENERAL LOCATION AND SITE DESCRIPTION

1. Site Location

- Urban Cottages Tejon Street is located on Lots 1-6 of the Raritan Estates Subdivision in the Northwest Quarter of Section 16, Township 3 South, Range 68 West, 6th Principal Meridian in the County of Adams, State of Colorado.
- See Appendix A for Vicinity Map
- The project is bordered to the West by Tejon Street and an unplatted area; to the East by Raritan Street; to the North by Lot 3 Block 1 of the Madera Subdivision and Lots 5 8 Block 5 of Carol Sue Heights; and to the South by Lots 1, 2, and 19 of the Tejon Heights Subdivision.

2. Description of Property

- The project site is a parcel of approximately 1.81 acres consisting of opens space with native grasses and trees, privacy and chain link fencing, a residence with two driveways and a garage, concrete slabs and sidewalk, brick pad, and various utilities. Topography generally slopes from west to east with grades between 1% and 7%.
- The project area is contained within FEMA Flood Insurance Rate Maps (FIRM) Panel Number 08001C0592H effective March 3rd, 2007. The site is located in an area of minimal flood hazard (Zone X). See Appendix A for a FEMA FIRM Panel Exhibit.
- The proposed Urban Cottages Tejon Street development includes the construction of 12 single family homes and associated infrastructure.
- Soil types in the project area as identified by the Natural Resources Conservation Service (NRCS) are as follows:

Hydrologic Soil Group— Adams County, Colorado						
Map unit symbol	Map unit name	Rating	Acres in AOI	Percent of AOI		
Gr	Gravelly land-Shale outcrop complex	А	2.1	100.0%		

See Appendix A for soils map.

B. DRAINAGE BASINS AND SUB BASINS

1. Major Drainage Basins

• The project site is located within the Globeville – Utah Junction Basin (Basin 0059-01) per the Denver Storm Drainage Master Plan, September 2014. Basin Drainage is predominantly west to east and outfalls to the South Platte River.

2. Minor Drainage Basins

- The proposed project site has been split into 3 onsite basins and an offsite basin for the purpose of evaluating runoff. Basin descriptions are as follows:
 - Basin D1 is the northern portion of the site and consists of rooftops, pavement, curb, gutter, sidewalk and landscaping. Runoff is conveyed to Design Point 1 via street section and curb and gutter where it is conveyed into a 2' sidewalk chase



URBAN COTTAGES – TEJON STREET

PRELIMINARY DRAINAGE REPORT

Page 2 of 4

- at Design Point 1. Once captured, runoff is conveyed through a swale to the onsite underground extended detention basin.
- Basin D2 is the southern portion of the site and consists of rooftops, sidewalk and landscaping. Runoff is conveyed to Design Point 3 via overland flow and swales where it is captured by nyloplast area drains and enters the proposed onsite underground extended detention basin.
- Basin D3 is the eastern portion of the site and consists of landscape, roof, and sidewalk. Runoff is conveyed to Design Point 4 via overland flow offsite into Raritan Street.
- Basin OS1 is an offsite basin consisting of rooftops, sidewalk, pavement and landscaping. Runoff is conveyed to Design Point 2 via overland flow where it enters Basin D2. Flows from this basin will ultimately be conveyed to the on-site underground extended detention basin. These flows will be considered bypass flows and are not intended to be detained.

C. DESIGN CRITERIA

1. Regulations

The project site has been designed in accordance with the Adams County Storm Drainage
Design and Stormwater Quality Regulations and the Urban Storm Drainage Criteria Manual,
Volumes 1, 2, and 3, from the Mile High Flood District.

2. Hydrologic Criteria

- Peak storm runoff was determined using the Rational Formula: Q=CIA
- Design storm recurrence intervals are the 5-year storm for the minor event and the 100-year storm for the major event.
- Table 9.3 of the Adams County Storm Drainage Design and Stormwater Quality Regulations was used to obtain rainfall depth-duration-frequency values for the project location. This corresponds to the following 1-hour point rainfall values (in): 5-yr = 1.42, 100-yr = 2.71.
- Runoff coefficients have been determined using Table 6-3 of the Urban Storm Drainage Criteria Manual, Volume 1.
- Time of Concentration has been calculated using the equations in USDCM Volume 1, Chapter 6, Section 2.4.
- Rainfall intensities were calculated using USDCM Volume 1's Equation 5-1.
- Detention Volume Computation Method: Water Quality and 100-year detention volume is
 provided by an on-site ADS underground extended detention basin. This basin is sized per the
 latest Urban Drainage and Flood Control District (UDFCD) Detention Basin Design Workbook
 "UD-Detention, Version 3.07 (February 2017)" with modifications as required by Adams County.
 - Infill projects are challenged from numerous standard requirements imposed from a new project perspective and the proven innovation with this proposed solution provides a viable solution that will be maintained by the owner and not the County that will provide for an additional 2-4 attainable units providing additional housing within Adams County.



URBAN COTTAGES – TEJON STREET

PRELIMINARY DRAINAGE REPORT

Page 3 of 4

Additionally, this innovative solution provides for a better buffer, removal of unsightly drainage elements and a cohesive surface from the front of the units to the property line for more useable space.

See Appendix B for all hydrologic calculations.

Hydraulic Criteria

- The UD-Inlet_v5.01 spreadsheet will be used to calculate inlet and street capacities throughout the site.
- Hydraulic Grade Lines (HGLs) will be contained within the pipe for minor event and below the
 proposed surface at the storm system structures for the major event. HGLs will be calculated
 using the Hydraflow Storm Sewers Extension for Civil 3D program with standard loss coefficients.
- See Appendix C for all hydraulic calculations.

D. STORMWATER IMPROVEMENTS

1. General Concept

 The proposed site has been graded to direct runoff toward a proposed underground extended detention basin located at the southeast corner of the property. Private storm sewer will be designed to collect runoff and convey it to the ADS underground detention basin.

2. Proposed Detention Facility

- A proposed ADS underground extended detention basin will provide attenuation for all runoff generated within the fully developed property. Stormwater will enter the detention facility via private storm sewer.
- A proposed outlet structure will be used to control release rates for the water quality capture volume (WQCV), the 5-year detention volume and the 100-year detention volume.
- The WQCV was calculated using the latest Urban Drainage and Flood Control District (UDFCD)
 Detention Basin Design Workbook "UD-Detention, Version 4.04 (February 2021)". Detention
 volumes were calculated using the empirical method presented in the County's drainage manual.
 Water Quality volumes were added to the 5 and 100-year volumes as described in the manual
 using user defined volumes in the UDFCD Workbook.
- Maximum allowable release rates were determined using Table 9.16 of the Adams County Storm Drainage Design and Stormwater Quality Regulations.
- The proposed ADS underground extended detention basin outfalls to a proposed storm sewer network in Raritan Street. This network connects to the existing storm sewer in West 52nd place at the Raritan Street intersection.
- Maintenance of the ADS underground extended detention basin will be provided by the property owners of Urban Cottages – Tejon Street. As the detention system is underground, the area above the system can be used for open space and minor landscape.



URBAN COTTAGES – TEJON STREET

PRELIMINARY DRAINAGE REPORT

Page 4 of 4

- In the event that the outlet structure for the underground extended detention basin fails, runoff will be conveyed through an emergency overflow at the outlet manhole on the east side of the basin which will convey flows to Raritan Street.
- See Appendix C for all detention calculations.

E. CONCLUSIONS

- 1. Compliance with Standards
- The drainage design for Urban Cottages Tejon Street detailed with in this report is in general compliance with the Adams County Storm Drainage Design and Stormwater Quality Regulations.
 - 2. Variances
- There are no variances requested for the project at this time.
 - Drainage Concept
- The proposed drainage patterns will follow historic flow patterns as closely as possible. On-site
 runoff will be conveyed to the proposed underground extended detention basin located at the
 southeast corner of the property for water quality enhancement and attenuation.
- The development of Urban Cottages Tejon Street will not adversely impact downstream properties or drainage facilities.


F. REFERENCES

- Storm Drainage Design and Stormwater Quality Regulations, Adams County, December 8, 2020
- 2. Urban Storm Drainage Criteria Manual, Volumes 1, 2, and 3, Mile High Flood District, Revised January 2021.



APPENDIX A - MAPS AND EXHIBITS

LOTS 1-6 AND TRACT A, RARITAN ESTATES SUBDIVISION LOCATED IN THE NORTHWEST QUARTER OF SECTION 16, TOWNSHIP 3 SOUTH, RANGE 68 WEST, 6TH PRINCIPAL MERIDIAN COUNTY OF ADAMS, STATE OF COLORADO

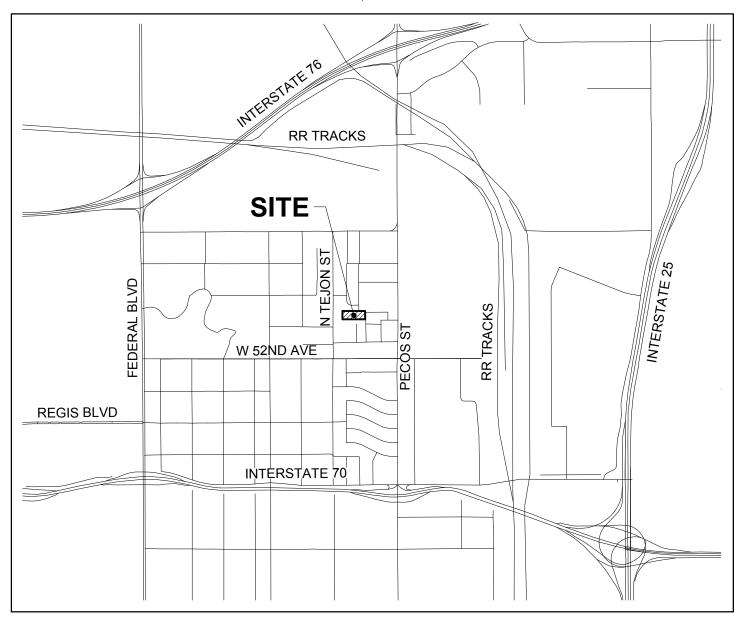



National Flood Hazard Layer FIRMette




Basemap: USGS National Map: Orthoimagery: Data refreshed October, 2020



Legend

SEE FIS REPORT FOR DETAILED LEGEND AND INDEX MAP FOR FIRM PANEL LAYOUT

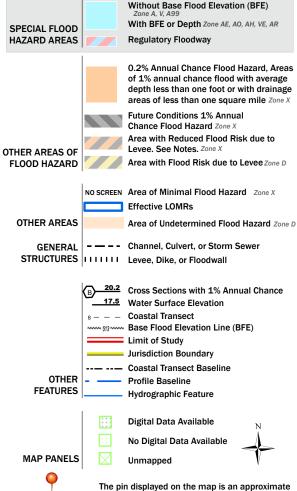

This map complies with FEMA's standards for the use of digital flood maps if it is not void as described below. The basemap shown complies with FEMA's basemap accuracy standards

point selected by the user and does not represent

an authoritative property location.

The flood hazard information is derived directly from the authoritative NFHL web services provided by FEMA. This map was exported on 1/20/2022 at 10:26 AM and does not reflect changes or amendments subsequent to this date and time. The NFHL and effective information may change or become superseded by new data over time.

This map image is void if the one or more of the following map elements do not appear: basemap imagery, flood zone labels, legend, scale bar, map creation date, community identifiers, FIRM panel number, and FIRM effective date. Map images for unmapped and unmodernized areas cannot be used for regulatory purposes.

MAP LEGEND MAP INFORMATION The soil surveys that comprise your AOI were mapped at Area of Interest (AOI) С 1:20.000. Area of Interest (AOI) C/D Soils Warning: Soil Map may not be valid at this scale. D **Soil Rating Polygons** Enlargement of maps beyond the scale of mapping can cause Not rated or not available Α misunderstanding of the detail of mapping and accuracy of soil **Water Features** line placement. The maps do not show the small areas of A/D contrasting soils that could have been shown at a more detailed Streams and Canals Transportation B/D Rails ---Please rely on the bar scale on each map sheet for map measurements. Interstate Highways C/D Source of Map: Natural Resources Conservation Service **US Routes** Web Soil Survey URL: D Major Roads Coordinate System: Web Mercator (EPSG:3857) Not rated or not available -Local Roads Maps from the Web Soil Survey are based on the Web Mercator projection, which preserves direction and shape but distorts Soil Rating Lines Background distance and area. A projection that preserves area, such as the Aerial Photography Albers equal-area conic projection, should be used if more accurate calculations of distance or area are required. This product is generated from the USDA-NRCS certified data as of the version date(s) listed below. Soil Survey Area: Adams County Area, Parts of Adams and Denver Counties, Colorado Survey Area Data: Version 18, Aug 31, 2021 Soil map units are labeled (as space allows) for map scales 1:50,000 or larger. Not rated or not available Date(s) aerial images were photographed: Oct 20, 2018—Oct **Soil Rating Points** 26, 2018 The orthophoto or other base map on which the soil lines were A/D compiled and digitized probably differs from the background imagery displayed on these maps. As a result, some minor shifting of map unit boundaries may be evident. B/D

Hydrologic Soil Group

Map unit symbol	Map unit name	Rating	Acres in AOI	Percent of AOI
Gr	Gravelly land-Shale outcrop complex	А	2.1	100.0%
Totals for Area of Intere	st		2.1	100.0%

Description

Hydrologic soil groups are based on estimates of runoff potential. Soils are assigned to one of four groups according to the rate of water infiltration when the soils are not protected by vegetation, are thoroughly wet, and receive precipitation from long-duration storms.

The soils in the United States are assigned to four groups (A, B, C, and D) and three dual classes (A/D, B/D, and C/D). The groups are defined as follows:

Group A. Soils having a high infiltration rate (low runoff potential) when thoroughly wet. These consist mainly of deep, well drained to excessively drained sands or gravelly sands. These soils have a high rate of water transmission.

Group B. Soils having a moderate infiltration rate when thoroughly wet. These consist chiefly of moderately deep or deep, moderately well drained or well drained soils that have moderately fine texture to moderately coarse texture. These soils have a moderate rate of water transmission.


Group C. Soils having a slow infiltration rate when thoroughly wet. These consist chiefly of soils having a layer that impedes the downward movement of water or soils of moderately fine texture or fine texture. These soils have a slow rate of water transmission.

Group D. Soils having a very slow infiltration rate (high runoff potential) when thoroughly wet. These consist chiefly of clays that have a high shrink-swell potential, soils that have a high water table, soils that have a claypan or clay layer at or near the surface, and soils that are shallow over nearly impervious material. These soils have a very slow rate of water transmission.


If a soil is assigned to a dual hydrologic group (A/D, B/D, or C/D), the first letter is for drained areas and the second is for undrained areas. Only the soils that in their natural condition are in group D are assigned to dual classes.

Rating Options

Aggregation Method: Dominant Condition
Component Percent Cutoff: None Specified

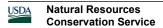

Tie-break Rule: Higher

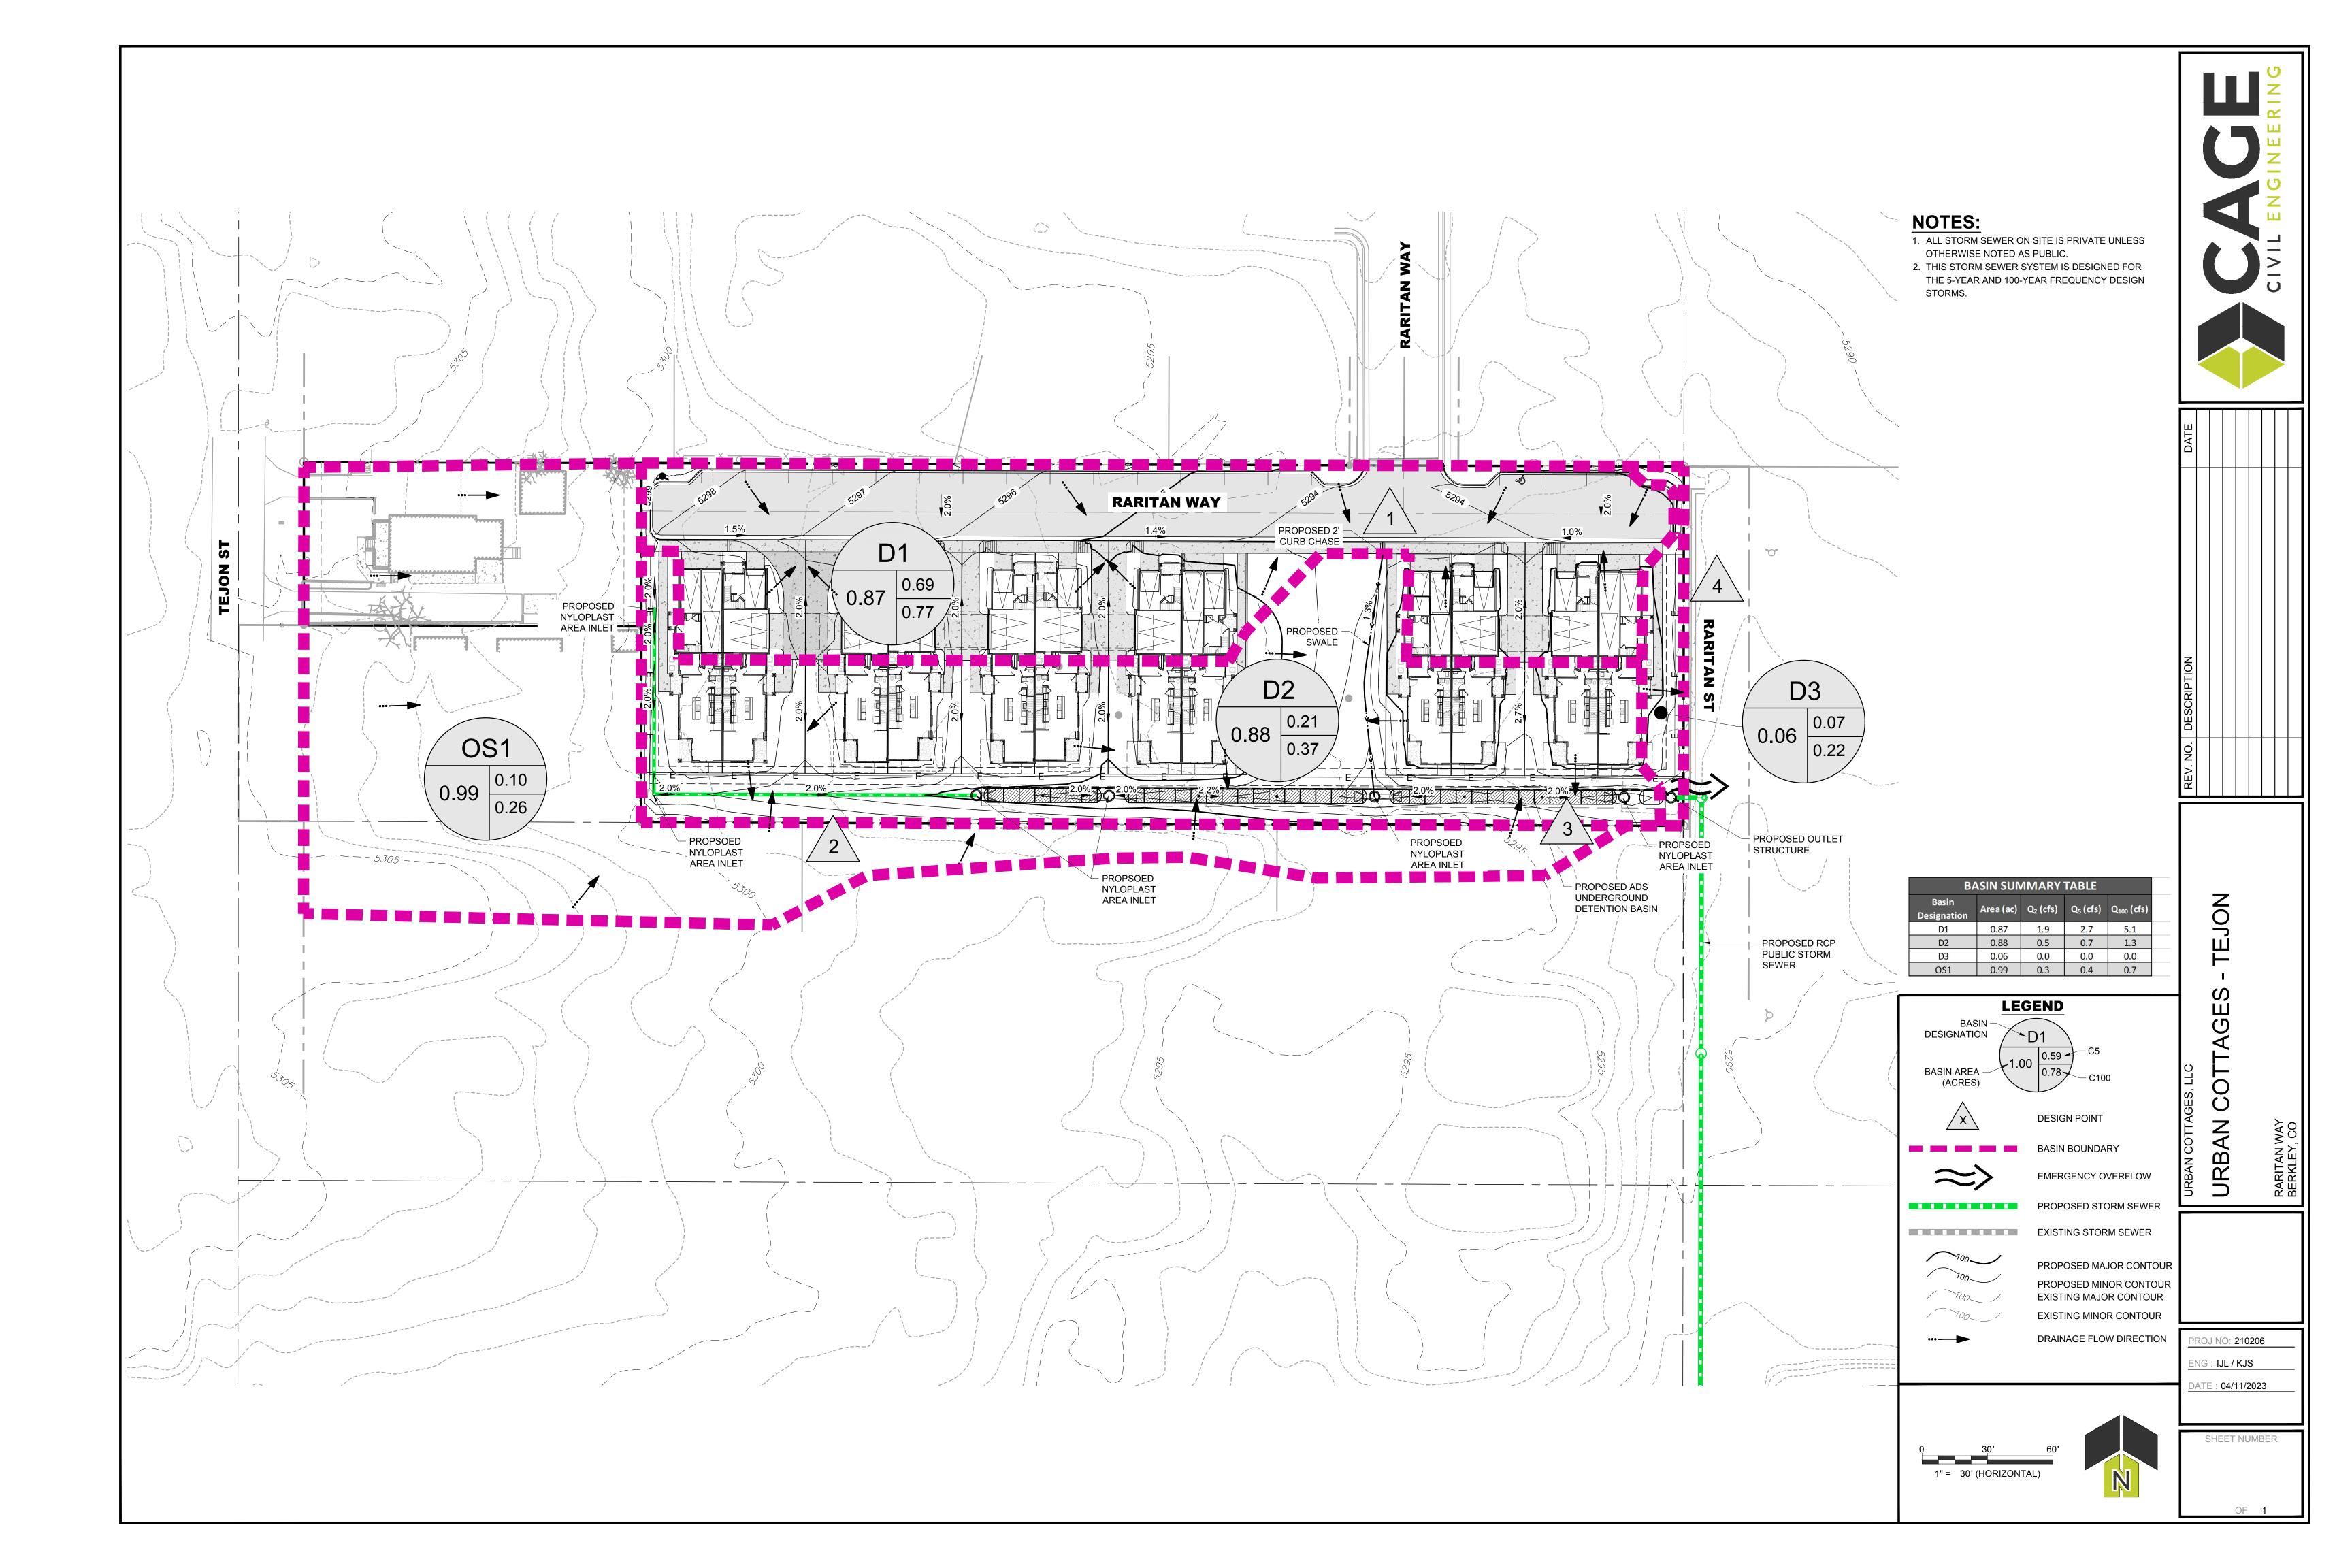

APPENDIX B - HYDROLOGIC COMPUTATIONS



Project: Urban Cottages Tejon

Location: Adams County, CO

Designer: RAK/KJS

Date: 1/26/2022

Latest Revision: 4/11/2023

¹From Table 6-3 in UDFCD Volume 1 ²From Table 6-4 in UDFCD Volume 1

IMPERVIOUSNESS AND RUNOFF COEFFICIENT CALCULATIONS

				Roofs	Lawn	Pavement	Pavement					
			Impervious % ¹	90%	2%	100%	90%					
Pacin Decimation	NRCS Hydrologic Soil	Total Area	Total Area	Roofs	Lawn	Pavement	Concrete	Percent	R	lunoff Coeff	icients, C ²	
Basin Designation	Group	(ac)	(sf)	(sf)	(sf)	(sf)	(sf)	Impervious	C_2	C_5	C ₁₀	C ₁₀₀
D1	Α	0.87	37,943	10,776	4,130	14,915	8,122	84.35%	0.67	0.69	0.71	0.77
D2	A	0.88	38,526	11,994	25,072	0	1,460	32.73%	0.20	0.21	0.22	0.37
D3	A	0.06	2,538	82	2,180	0	276	14.41%	0.07	0.07	0.08	0.22
Onsite Total		1.81	79,007	22,852	31,382	14,915	9,858	56.93%	0.42	0.44	0.45	0.55
OS1	A	0.99	43,239	7,773	34,786	57	623	19.22%	0.10	0.10	0.11	0.26
Overall Total		2.81	122,246	30,625	66,168	14,972	10,481	43.59%	0.31	0.32	0.33	0.45



Project: Urban Cottages Tejon Location: Adams County, CO Designer: RAK/KJS Date: 1/26/2022 Latest Revision: 4/11/2023

NRCS Conveyance Fa	actors, K ²
Type of Land Surface	K
Heavy Meadow	2.5
Tillage/Field	5
Short Pasture/Lawns	7
Nearly Bare Ground	10
Grassed Waterway	15
Paved Areas	20

¹Max 300 ft in Urban areas and 500 ft in rural areas ²From Table 6-2 in UDFCD Volume 1 Minimum T_c

TIME OF CONCENTRATION CALCULATIONS

			Initial/	Overland Flo	ow Time, T _i		Channelized Flow/Travel Time, T _t j					ime of Concentration, T_c (Check		
Basin Designation	Imperviousness (%)	C ₅	Length (ft) ¹	Slope (%)	T _i (min)	Land Surface	Length (ft)	Slope (%)	Velocity (ft/sec)	T _t (min)	Computed T _c (min)	First Design Point T _c (min)	Selected T _c (min)	
D1	84.35%	0.69	50	2.5	3.8	Paved Areas	305	1.5	2.45	2.1	5.9	13.7	5.90	
D2	32.73%	0.21	30	2.0	7.0	Paved Areas	235	1.0	2.03	1.9	8.9	23.3	8.90	
D3	14.41%	0.07	20	10.0	3.9	Paved Areas	1	10.0	6.3	0.0	3.9	N/A	5.00	
OS1	19.22%	0.10	89	7.6	8.7	Paved Areas	64	0.2	0.79	1.4	10.1	N/A	10.10	

2.4.1 Initial or Overland Flow Time

The initial or overland flow time, ti, may be calculated using Equation 6-3:

$$t_i = \frac{0.395(1.1 - C_5)\sqrt{L_i}}{S_o^{0.33}}$$

Equation 6-3

- t_i = overland (initial) flow time (minutes)
- C_5 = runoff coefficient for 5-year frequency (from Table 6-4)
- L_i = length of overland flow (ft)
- S_0 = average slope along the overland flow path (ft/ft).

2.4.2 Channelized Flow Time

The channelized flow time (travel time) is calculated using the hydraulic properties of the conveyance element. The channelized flow time, to, is estimated by dividing the length of conveyance by the velocity. The following equation, Equation 6-4 (Giuo 2013), can be used to determine the flow velocity in conjunction with Table 6-2 for the conveyance factor.

$$L_t = \frac{L_t}{60K\sqrt{S_o}} = \frac{L_t}{60V_t}$$
 Equation 6-4

- t_t = channelized flow time (travel time, min)
- t_t = channelized flow time (travel time, if L_t = waterway length (ft) S_o = waterway slope (ft/ft) V_t = travel time velocity (ft/sec) = $K\sqrt{S_o}$
- K = NRCS conveyance factor (see Table 6-2).

$t_c = t_i + t_t$

Equation

Where:

- t_c = computed time of concentration (minutes)
- t_i = overland (initial) flow time (minutes)
- t_i = channelized flow time (minutes).

2.4.3 First Design Point Time of Concentration in Urban Catchments

Equation 6-4 was solely determined by the waterway characteristics and using a set of empirical formulas. A calibration study between the Rational Method and the Colorado Urban Hydrograph Procedure (CUHP) suggests that the time of concentration shall be the lesser of the values calculated by Equation 6-2 and Equation 6-5 (Guo and Urbonas 2013).

$$t = (26-17i) + \frac{L_t}{60(14i+9)\sqrt{S_t}}$$
 Equation 6-5

Where:

- t_c = minimum time of concentration for first design point when less than t_c from Equation 6-1.
- L_t = length of channelized flow path (ft)
- i = imperviousness (expressed as a decimal)
 S_t = slope of the channelized flow path (ft/ft).

2.4.4 Minimum Time of Concentration

Use a minimum t_c value of 5 minutes for urbanized areas and a minimum t_c value of 10 minutes for areas that are not considered urban. Use minimum values even when calculations result in a lesser time of



Project: <u>Urban Cottages Tejon</u> Location: <u>Adams County, CO</u>

Designer: RAK/KJS

Date: 1/26/2022

Latest Revision: 4/11/2023

Design Storm: 5-Yr
1-hr Design Point Rainfall (in): 1.42

5-YEAR PEAK RUNOFF CALCULATIONS

Basin Designation	Design Point	Area (ac)	C_5	CXA	T _c (min)	Intensity (in/hr)	Peak Flow, Q (cfs)
D1	1	0.87	0.67	0.59	5.90	4.60	2.7
D2	2	0.88	0.20	0.17	8.90	4.02	0.7
D3	3	0.06	0.07	0.00	5.00	4.82	0.0
OS1	4	0.99	0.10	0.10	10.10	3.83	0.4



Project: <u>Urban Cottages Tejon</u> Location: Adams County, CO

Designer: RAK/KJS

Date: 1/26/2022

Latest Revision: 4/11/2023

Design Storm: 100-Yr
1-hr Design Point Rainfall (in): 2.71

100-YEAR PEAK RUNOFF CALCULATIONS

Basin Designation	Design Point	Area (ac)	C ₁₀₀	CXA	T _c (min)	Intensity (in/hr)	Peak Flow, Q (cfs)
D1	1	0.87	0.67	0.59	5.90	8.78	5.1
D2	2	0.88	0.20	0.17	8.90	7.67	1.3
D3	3	0.06	0.07	0.00	5.00	9.19	0.0
OS1	4	0.99	0.10	0.10	10.10	7.30	0.7

APPENDIX C - HYDRAULIC CALCULATIONS

DETENTION VOLUME CALCULATIONS

V=KA

Equation 9.5

For the 100-year:

$$K_{100} = \frac{\left(1.78I - 0.002I^2 - 3.56\right)}{910}$$

Equation 9.6

For the 5-year:

$$K_5 = \frac{\left(0.77I - 2.26\right)}{1000}$$

Equation 9.7

 $\begin{array}{lll} I = & & 56.93 \ \% \\ A = & & 1.81 \ AC \\ K_5 = & & 0.042 \\ K_{100} = & & 0.100 \end{array}$

V ₅ =	0.075 AC-FT
V ₁₀₀ =	0.182 AC-FT

ALLOWABLE RELEASE RATES

Table 9.16—Allowable Release Rates (CFS/Acre)

Control Francisco			
Control Frequency	Α	В	C&D
5-year	0.07	0.13	0.17
100-year	0.50	0.85	1.00

SCS Hydrologic Soil Group: A Tributary Area = 2.04 AC

Calculated 5-Year Allowable Release Rate =	0.14 CFS
Calculated 100-Year Allowable Release Rate =	1.02 CFS

DETENTION BASIN STAGE-STORAGE TABLE BUILDER

		Detention, Version 4	1.04 (Febr	uary 2021)	1						
Project: <u>Urban Cotta</u> Basin ID: Extended D											
ZONE 3	etention Basin										
100-YR											
100-YR POLUME EURY WOCV		-		_							
PERMANENT ORIFICES	100-YEAR ORIFICE	Depth Increment =		ft Optional		1	1	Optional			
PERMANENT ORIFICES POOL Example Zone Configura	tion (Retention Pond)	Stage - Storage	Stage	Override	Length	Width	Area	Override	Area	Volume	Volume
Watershed Information		Description Top of Micropool	(ft) 	Stage (ft) 0.00	(ft) 	(ft) 	(ft ²)	Area (ft 2) 1,589	(acre) 0.036	(ft 3)	(ac-ft)
Selected BMP Type = EDB	1			1.00				1,589	0.036	1,589	0.036
Watershed Area = 1.81	acres			2.00				1,589	0.036	3,178	0.073
Watershed Length = 634	ft			3.00				1,589	0.036	4,767	0.109
Watershed Length to Centroid = 317 Watershed Slope = 0.019	ft/ft			4.00 5.00				1,589 1,589	0.036	6,356 7,945	0.146 0.182
Watershed Imperviousness = 56.93%	percent			5.50				1,589	0.036	8,739	0.201
Percentage Hydrologic Soil Group A = 100.0%	percent				-						
Percentage Hydrologic Soil Group B = 0.0%	percent										
Percentage Hydrologic Soil Groups C/D = 0.0% Target WQCV Drain Time = 40.0	percent hours										
Location for 1-hr Rainfall Depths = User Input											
After providing required inputs above including 1-hour											
depths, click 'Run CUHP' to generate runoff hydrograph the embedded Colorado Urban Hydrograph Proced	ure. Optional User Overrides										
Water Quality Capture Volume (WQCV) = 0.034	acre-feet acre-feet										
Excess Urban Runoff Volume (EURV) = 0.123	acre-feet acre-feet										
2-yr Runoff Volume (P1 = 1 in.) = 0.074	acre-feet 1.00 inches										
5-yr Runoff Volume (P1 = 1.42 in.) = 0.111 10-yr Runoff Volume (P1 = 1.68 in.) = 0.135	acre-feet 1.42 inches acre-feet 1.68 inches										
25-yr Runoff Volume (P1 = 2.35 in.) = 0.220	acre-feet 2.35 inches										
50-yr Runoff Volume (P1 = 2.71 in.) = 0.267	acre-feet 2.71 inches										
100-yr Runoff Volume (P1 = 2.31 in.) = 0.218 500-yr Runoff Volume (P1 = 3.14 in.) = 0.334	acre-feet inches										
Approximate 2-yr Detention Volume = 0.067	acre-feet										
Approximate 5-yr Detention Volume = 0.099	acre-feet				-						
Approximate 10-yr Detention Volume = 0.122 Approximate 25-yr Detention Volume = 0.181	acre-feet acre-feet										
Approximate 20-yr Detention Volume = 0.205	acre-feet										
Approximate 100-yr Detention Volume = 0.174	acre-feet										
Define Zones and Basin Geometry Zone 1 Volume (WQCV) = 0.034	acre-feet V5										
Zone 2 Volume (User Defined - Zone 1) = 0.075	acre-feet										
Zone 3 Volume (User Defined - Zones 1 & 2) = 0.090	acre-feet <table-cell-rows></table-cell-rows>	* WQCV									
Total Detention Basin Volume = 0.199 Initial Surcharge Volume (ISV) = user	acre-feet ft 3										
Initial Surcharge Depth (ISD) = user	ft										
Total Available Detention Depth (H _{total}) = user	ft										
Depth of Trickle Channel (H _{TC}) = user	ft										
Slope of Trickle Channel (S _{TC}) = user Slopes of Main Basin Sides (S _{main}) = user	ft/ft H:V										
Basin Length-to-Width Ratio (R _{L/W}) = user											
	- -										
Initial Surcharge Area (A _{ISV}) = user Surcharge Volume Length (L _{ISV}) = user	ft ²										
Surcharge Volume Width (W _{ISV}) = user	ft										
Depth of Basin Floor (H _{FLOOR}) = user	ft										
Length of Basin Floor $(L_{FLOOR}) = user$ Width of Basin Floor $(W_{FLOOR}) = user$	ft ft										
Area of Basin Floor (A _{FLOOR}) = user	ft ²										
Volume of Basin Floor (V _{FLOOR}) = user	ft ³				-						
Depth of Main Basin (H _{MAIN}) = user Length of Main Basin (L _{MAIN}) = user	ft										
Length of Main Basin $(L_{MAIN}) = user$ Width of Main Basin $(W_{MAIN}) = user$	ft										
Area of Main Basin (A _{MAIN}) = user	ft ²				-						
Volume of Main Basin (V _{MAIN}) = user	ft ³										
Calculated Total Basin Volume (V _{total}) = user	acre-feet										
					-						
					-						
					-						
					-						
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					1 1						
					-						
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			-				-				

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APPENDIX D - REFERENCED MATERIALS

Runoff Chapter 6

Table 6-3. Recommended percentage imperviousness values

Land Use or	Percentage Imperviousness
Surface Characteristics	(%)
Business:	
Downtown Areas	95
Suburban Areas	75
Residential lots (lot area only):	
Single-family	
2.5 acres or larger	12
0.75 – 2.5 acres	20
0.25 – 0.75 acres	30
0.25 acres or less	45
Apartments	75
Industrial:	
Light areas	80
Heavy areas	90
Parks, cemeteries	10
Playgrounds	25
Schools	55
Railroad yard areas	50
Undeveloped Areas:	
Historic flow analysis	2
Greenbelts, agricultural	2
Off-site flow analysis (when land use not defined)	45
Streets:	
Paved	100
Gravel (packed)	40
Drive and walks	90
Roofs	90
Lawns, sandy soil	2
Lawns, clayey soil	2

Runoff Chapter 6

Table 6-5. Runoff coefficients, c

T-4-1 Eff. 4:		1 abie 0-5	NDCC II1	-1	C 1		
Total or Effective	2.17	7.3 7	NRCS Hydr			100 37	500 N/
% Impervious	2-Year	5-Year	10-Year	25-Year	50-Year	100-Year	500-Year
2%	0.01	0.01	0.01	0.01	0.04	0.13	0.27
5%	0.02	0.02	0.02	0.03	0.07	0.15	0.29
10%	0.04	0.05	0.05	0.07	0.11	0.19	0.32
15%	0.07	0.08	0.08	0.1	0.15	0.23	0.35
20%	0.1	0.11	0.12	0.14	0.2	0.27	0.38
25%	0.14	0.15	0.16	0.19	0.24	0.3	0.42
30%	0.18	0.19	0.2	0.23	0.28	0.34	0.45
35%	0.21	0.23	0.24	0.27	0.32	0.38	0.48
40%	0.25	0.27	0.28	0.32	0.37	0.42	0.51
45%	0.3	0.31	0.33	0.36	0.41	0.46	0.54
50%	0.34	0.36	0.37	0.41	0.45	0.5	0.58
55%	0.39	0.4	0.42	0.45	0.49	0.54	0.61
60%	0.43	0.45	0.47	0.5	0.54	0.58	0.64
65%	0.48	0.5	0.51	0.54	0.58	0.62	0.67
70%	0.53	0.55	0.56	0.59	0.62	0.65	0.71
75%	0.58	0.6	0.61	0.64	0.66	0.69	0.74
80%	0.63	0.65	0.66	0.69	0.71	0.73	0.77
85%	0.68	0.7	0.71	0.74	0.75	0.77	0.8
90%	0.73	0.75	0.77	0.79	0.79	0.81	0.84
95%	0.79	0.81	0.82	0.83	0.84	0.85	0.87
100%	0.84	0.86	0.87	0.88	0.88	0.89	0.9
Total or Effective			NRCS Hydr	ologic Soil	Group B		
% Impervious	2-Year	5-Year	10-Year	25-Year	50-Year	100-Year	500-Year
2%	0.01	0.01	0.07	0.26	0.34	0.44	0.54
5%	0.03	0.03	0.1	0.28	0.36	0.45	0.55
10%	0.06	0.07	0.14	0.31	0.38	0.47	0.57
15%			0.40	0.24			
	0.09	0.11	0.18	0.34	0.41	0.5	0.59
20%	0.09	0.11	0.18	0.34	0.41	0.5 0.52	0.59 0.61
20% 25%							
	0.13	0.15	0.22	0.38	0.44	0.52	0.61
25%	0.13 0.17	0.15 0.19	0.22 0.26	0.38 0.41	0.44 0.47	0.52 0.54	0.61 0.63
25% 30%	0.13 0.17 0.2	0.15 0.19 0.23	0.22 0.26 0.3	0.38 0.41 0.44	0.44 0.47 0.49	0.52 0.54 0.57	0.61 0.63 0.65
25% 30% 35%	0.13 0.17 0.2 0.24	0.15 0.19 0.23 0.27	0.22 0.26 0.3 0.34	0.38 0.41 0.44 0.47	0.44 0.47 0.49 0.52	0.52 0.54 0.57 0.59	0.61 0.63 0.65 0.66
25% 30% 35% 40%	0.13 0.17 0.2 0.24 0.29	0.15 0.19 0.23 0.27 0.32	0.22 0.26 0.3 0.34 0.38	0.38 0.41 0.44 0.47 0.5	0.44 0.47 0.49 0.52 0.55	0.52 0.54 0.57 0.59 0.61	0.61 0.63 0.65 0.66 0.68
25% 30% 35% 40% 45%	0.13 0.17 0.2 0.24 0.29 0.33	0.15 0.19 0.23 0.27 0.32 0.36	0.22 0.26 0.3 0.34 0.38 0.42	0.38 0.41 0.44 0.47 0.5 0.53	0.44 0.47 0.49 0.52 0.55 0.58	0.52 0.54 0.57 0.59 0.61 0.64	0.61 0.63 0.65 0.66 0.68 0.7
25% 30% 35% 40% 45% 50%	0.13 0.17 0.2 0.24 0.29 0.33 0.37	0.15 0.19 0.23 0.27 0.32 0.36 0.4	0.22 0.26 0.3 0.34 0.38 0.42 0.46	0.38 0.41 0.44 0.47 0.5 0.53 0.56	0.44 0.47 0.49 0.52 0.55 0.58 0.61	0.52 0.54 0.57 0.59 0.61 0.64 0.66	0.61 0.63 0.65 0.66 0.68 0.7 0.72
25% 30% 35% 40% 45% 50% 55%	0.13 0.17 0.2 0.24 0.29 0.33 0.37 0.42	0.15 0.19 0.23 0.27 0.32 0.36 0.4 0.45	0.22 0.26 0.3 0.34 0.38 0.42 0.46 0.5	0.38 0.41 0.44 0.47 0.5 0.53 0.56 0.6	0.44 0.47 0.49 0.52 0.55 0.58 0.61 0.63	0.52 0.54 0.57 0.59 0.61 0.64 0.66 0.68	0.61 0.63 0.65 0.66 0.68 0.7 0.72 0.74
25% 30% 35% 40% 45% 50% 55% 60%	0.13 0.17 0.2 0.24 0.29 0.33 0.37 0.42 0.46	0.15 0.19 0.23 0.27 0.32 0.36 0.4 0.45 0.49	0.22 0.26 0.3 0.34 0.38 0.42 0.46 0.5 0.54	0.38 0.41 0.44 0.47 0.5 0.53 0.56 0.6 0.63	0.44 0.47 0.49 0.52 0.55 0.58 0.61 0.63 0.66	0.52 0.54 0.57 0.59 0.61 0.64 0.66 0.68 0.71	0.61 0.63 0.65 0.66 0.68 0.7 0.72 0.74 0.76
25% 30% 35% 40% 45% 50% 55% 60% 65%	0.13 0.17 0.2 0.24 0.29 0.33 0.37 0.42 0.46 0.5	0.15 0.19 0.23 0.27 0.32 0.36 0.4 0.45 0.49 0.54	0.22 0.26 0.3 0.34 0.38 0.42 0.46 0.5 0.54 0.58	0.38 0.41 0.44 0.47 0.5 0.53 0.56 0.6 0.63 0.66	0.44 0.47 0.49 0.52 0.55 0.58 0.61 0.63 0.66 0.69	0.52 0.54 0.57 0.59 0.61 0.64 0.66 0.68 0.71 0.73	0.61 0.63 0.65 0.66 0.68 0.7 0.72 0.74 0.76 0.77
25% 30% 35% 40% 45% 50% 55% 60% 65% 70%	0.13 0.17 0.2 0.24 0.29 0.33 0.37 0.42 0.46 0.5 0.55	0.15 0.19 0.23 0.27 0.32 0.36 0.4 0.45 0.49 0.54 0.58	0.22 0.26 0.3 0.34 0.38 0.42 0.46 0.5 0.54 0.58 0.62	0.38 0.41 0.44 0.47 0.5 0.53 0.56 0.6 0.63 0.66 0.69	0.44 0.47 0.49 0.52 0.55 0.61 0.63 0.66 0.69 0.72	0.52 0.54 0.57 0.59 0.61 0.64 0.66 0.68 0.71 0.73 0.75	0.61 0.63 0.65 0.66 0.68 0.7 0.72 0.74 0.76 0.77
25% 30% 35% 40% 45% 50% 55% 60% 65% 70%	0.13 0.17 0.2 0.24 0.29 0.33 0.37 0.42 0.46 0.5 0.55 0.6	0.15 0.19 0.23 0.27 0.32 0.36 0.4 0.45 0.49 0.54 0.58 0.63	0.22 0.26 0.3 0.34 0.38 0.42 0.46 0.5 0.54 0.62 0.66	0.38 0.41 0.44 0.47 0.5 0.53 0.56 0.6 0.63 0.66 0.69 0.72	0.44 0.47 0.49 0.52 0.55 0.58 0.61 0.63 0.66 0.69 0.72 0.75	0.52 0.54 0.57 0.59 0.61 0.64 0.66 0.71 0.73 0.75 0.78	0.61 0.63 0.65 0.66 0.68 0.7 0.72 0.74 0.76 0.77 0.79 0.81
25% 30% 35% 40% 45% 50% 55% 60% 65% 70% 75% 80%	0.13 0.17 0.2 0.24 0.29 0.33 0.37 0.42 0.46 0.5 0.55 0.6 0.64	0.15 0.19 0.23 0.27 0.32 0.36 0.4 0.45 0.49 0.54 0.58 0.63 0.67	0.22 0.26 0.3 0.34 0.38 0.42 0.46 0.5 0.54 0.58 0.62 0.66 0.7	0.38 0.41 0.44 0.47 0.5 0.53 0.56 0.6 0.63 0.66 0.69 0.72 0.75	0.44 0.47 0.49 0.52 0.55 0.58 0.61 0.63 0.66 0.69 0.72 0.75 0.77	0.52 0.54 0.57 0.59 0.61 0.64 0.66 0.71 0.73 0.75 0.78 0.8	0.61 0.63 0.65 0.66 0.68 0.7 0.72 0.74 0.76 0.77 0.79 0.81 0.83
25% 30% 35% 40% 45% 50% 55% 60% 65% 70% 75% 80% 85%	0.13 0.17 0.2 0.24 0.29 0.33 0.37 0.42 0.46 0.5 0.65 0.64 0.69	0.15 0.19 0.23 0.27 0.32 0.36 0.4 0.45 0.49 0.54 0.58 0.63 0.67 0.72	0.22 0.26 0.3 0.34 0.38 0.42 0.46 0.5 0.54 0.58 0.62 0.66 0.7 0.74	0.38 0.41 0.44 0.47 0.5 0.53 0.56 0.6 0.63 0.66 0.72 0.75 0.78	0.44 0.47 0.49 0.52 0.55 0.58 0.61 0.63 0.66 0.69 0.72 0.75 0.77 0.8	0.52 0.54 0.57 0.59 0.61 0.64 0.66 0.71 0.73 0.75 0.78 0.8	0.61 0.63 0.65 0.66 0.7 0.72 0.74 0.76 0.77 0.79 0.81 0.83 0.85

9-01-04-03 RAINFALL

Presented in this Section are guidelines for the development of rainfall data to be used in preparing a hydrological analysis (storm runoff) for a proposed development within the County.

The rainfall intensity information published by the National Oceanic and Atmospheric Administration (NOAA) in the "Precipitation-Frequency Atlas of the Western United States" was used to develop incremental rainfall distributions presented in Table 9.5. The incremental rainfall distributions presented in this table are based on procedures developed by the MHFD. However, refinements have been made to closely match conditions within the County.

9-01-04-04 TIME-INTENSITY-FREQUENCY CURVES

A time-intensity-frequency curve was developed for the County by using one-hour point rainfall values (see Table 9.3) and factors for durations of less than one hour (see Table 9.4); both obtained from the NOAA Atlas. The outcomes of this distribution are point values that were then converted to intensities and plotted as Figure 9.1. Rainfall data from the Mile High Flood District (MHFD) may be used as an alternative (see MHFD Criteria Manual).

Table 9.3—One-Hour Point Rainfall (inches)

2-Year	5-Year	10-Year	50-Year	100-Year
1.00	1.42	1.68	2.35	2.71

Table 9.4—Factors for Durations of Less than One Hour

Duration (minutes)	5	10	15	30
Ratio to 1-hour depth	0.29	0.45	0.57	0.79

Community & Economic Development Department www.adcogov.org



4430 South Adams County Parkway 1st Floor, Suite W2000B Brighton, CO 80601-8218 PHONE 720.523.6800 FAX 720.523.6967

Development Team Review Comments

The following comments have been provided by reviewers of your land use application. At this time, a resubmittal of your application is required before this case is ready to be scheduled for public hearing.

To prepare your resubmittal, you will be expected to provide:

- A response to each comment with a description of the revisions and the page of the response on the site plan;
- Any revised plans or renderings; and
- A list identifying any additional changes made to the original submission other than those required by staff.

Resubmittal documents must be provided electronically through e-mail or a flash drive delivered to the One-Stop Customer Service Center. The following items will be expected by our One-Stop **Customer Service Center:**

- One digital copy of all new materials
 - o All digital materials shall be in a single PDF document
 - o The single PDF document shall be bookmarked
 - o If a Subdivision Improvements Agreement, Legal Description, or Development Agreement is required, then an additional Microsoft Word version of these documents shall also be provided
 - Electronic copies can be emailed to epermitcenter@adcogov.org as a PDF attachment. If the files are too large to attach, the email should include an unlocked Microsoft OneDrive link. Alternatively, the resubmittal can be delivered to the One-Stop counter on a flash drive.

Community & Economic Development Department www.adcogov.org



4430 South Adams County Parkway 1st Floor, Suite W2000 Brighton, CO 80601-8204 PHONE 720.523.6800 FAX 720.523.6998

Re-submittal Form

Case Name/ Number:
Case Manager:
Re-submitted Items:
Development Plan/ Site Plan
Plat
Parking/ Landscape Plan
Engineering Documents
Subdivision Improvements Agreement (<u>Microsoft Word version</u>)
Other:
All re-submittals must have this cover sheet and a cover letter addressing review comments.
Please note the re-submittal review period is 21 days.
The cover letter must include the following information:
Restate each comment that requires a response
 Provide a response below the comment with a description of the revisions Identify any additional changes made to the original document
For County Use Only:
Date Accepted:
Staff (accepting intake):
Resubmittal Active: Addressing, Building Safety, Neighborhood Services,
Engineering Environmental Parks Planner ROW SIA - Finance SIA - Attorney

Community & Economic Development Department Development Services Division

www.adcogov.org



4430 South Adams County Parkway 1st Floor, Suite W2000B Brighton, CO 80601-8218 PHONE 720.523.6800 FAX 720.523.6967

Development Review Team Comments- 2nd Review

Date: 11/04/2022

Project Number: PRC2022-00008

Project Name: Raritan Estates Redevelopment

Note to Applicant:

The following review comments and information from the Development Review Team is based on the information you submitted for a preliminary development plan, preliminary plat, waivers, and vacation. The Development Review Team review comments may change if you provide different information during the next submittal/ building permit. Please contact the case manager if you have any questions.

Also, please note where "Section" is referenced, it is referring to the appropriate section of the Adams County Development Standards and Regulations.

Commenting Division: Planning and Development

Name of Reviewer: Layla Bajelan, Senior Long Range Planner

Email: LBajelan@adcogov.org / 720-523-6863

SEE PROVIDED COMMENT RESPONSE LETTER

Preliminary Plat

PLN01: All lots appear to meet the minimum lot size and lot width proposed in the PDP

PLN02: Please switch the PC and BoCC approval blocks so the PC is on top, or before the BoCC.

Preliminary Development Plan

PLN01: Please switch the PC and BoCC approval blocks so the PC is on top, or before the BoCC.

PLN02: Remove the Clerk and Recorder signature block, as this is not recorded.

PLN04: Include an Attorney's verification signature line, similar to the plat.

PLN05: The PDP has a lot of information selling the project. This should be removed and included in written justification, that can be provided to the Commissioners during hearing. This is the technical document that property owners and County staff use to review the development and should only contain such information.

PLN06: Section A, paragraph 2, please remove the sentence "A CONCURRENT REZONE APPLICATION IS BEING SUBMITTED ALONG WITH THIS PUD-PDP TO PERMIT THE DEVELOPMENT OF THE PROPOSED RESIDENTIAL PRODUCT TYPE." as this does not need to be in this document.

PLN07: Page 2, Section E- This shall be completed and have no blanks. Please remove the County maintenance responsibilities from this.

PLN08: Page 2, Section K- This states no signage at this time, but page 3, note 3 says signage is conceptual. The PDP should set parameters on signs (materials, max height/width, etc.) if any signs will be proposed. This should be done at the time of PDP, but can be modified in the FDP.

PLN09: Page 2, Section O- Staff has concerns over the side yard use easement. Historically this has been confusing for property owners and makes permitting difficult.

PLN10: Page 2, Section Q- Please include a minimum percentage of visitor parking in the text.

PLN11: Page 2, Section S- Landscaping can be conceptual at the PDP stage, but staff does have concerns pertaining to screening for adjacent neighbors. Also, you are not requesting a wavier from the front setback tree plantings, so please remove this language. I am not sure what this is in reference to?

3-34-03-01-04 SCREENING REQUIRED: Improvements on the site shall be sight-screened with adequate landscaping so as to provide a compatible visual effect as seen from the adjoining properties.

PLN12: Page 2, Section T- This should be removed from the PDP and added to the written narrative.

PLN13: Page 3- The total acreage in the land use summary does not match what is on page 2, Section A. 2.04 acres vs. 2.08 acres

PLN14: Page 3- Please include a table with the parking dimensions. We typically see the parking plans with triangles showing all the parking spaces within the development. The site plan is fine, however a small demonstration of parking in the garage and the street should be shown. For example, how are cars being parked in the garage? Is this tandem or side by side? It is very hard to see the spaces on this site plan and they should be clearly shown.

PLN15: Please remove street cross sections (page 4) from the PDP.

PLN16: Page 5- This is fine if this is the only type of fencing allowed. Please keep in mind that if anyone proposed anything slightly different a PUD amendment would be required.

PLN17: Page 6- The percentages for open space and active open space are flipped.

3-34-03-05-06 PERCENTAGE OF OPEN SPACE REQUIRED A minimum of 30% Open Space shall be required in all P.U.D.s or as determined by the Board of County Commissioners.

3-34-03-05-03 USE OF OPEN SPACE At least twenty-five percent (25%) of the minimum required open space shall be designated for active recreation purposes, and no more than fifty percent (50%) shall be so utilized, in order to preserve a reasonable proportion of natural areas on the site. The purposes for which open space areas are proposed shall be documented.

Page 2 and 3 of the zoning map amendment document should be included in the PDP. It does a much better job of demonstrating the open space. Once again, staff has concerns pertaining to the active open space. While the development may be meeting the percentages, staff feels that the intent of the active open space requirements are not being met. Include parameters on structures.

PLN18: The elevations should also set parameters on materials, etc.

Commenting Division: Development Services, Right-of-Way Agent

Name of Reviewer: David Dittmer

Email: DDittmer@adcogov.org / 720-523-6811

ROW1: Revise Dedication and Ownership Certificate as provided by the application guidelines. This will be for the opening and closing statements as provided.

ROW2: Raritan Way is not to be continued through the subdivision. It should be labeled as W. 53rd Dr. Revise throughout sheets.

ROW3: "OWNER/UC TEJON, LLC" needs to be formatted ahead of the signature block.

ROW4: Signature block should read as:

OWNER: UC TEJON, LLC

CHASE STILLMAN

remove additional information. According to the recoded statement of authority found at Reception No: 2021000107861 this is the only signatory. There are two blocks. Is there another signatory?

ROW5: Notary Affirmation should read:

...ACKNOWLEDGED BEFORE ME THIS _____DAY OF _____ 2022, BY CHASE STILLMAN AS MANAGER OF UC TEJON, LLC, a/k/a URBAN COTTEGES TEJON, LLC....

ROW6: The Title Commitment will need to be updated to within 30 days of Final Plat application submission date or it cannot be approved.

ROW7: Note 6 appears to contradict the statement and citation as provided in the Title Commitment. Please review and revise as necessary.

ROW8: the order of appearance on the plat for acceptance and signature blocks is as follows: Owner

Surveyor
Planning Commission (revise as provided)
Board of County Commissioners

ROW9: Need to incorporate the TRACTS that are designated as private roads with public access into Note 6

ROW10: Label Note 7: STORM DRAINAGE FACILITIES STATEMENT

ROW11: Review the sanitation districts partial release and revise statements as necessary. It appears the entire easement was vacated, only a portion of the original easement is shown, and the ALTA provided has it shown in its entirety.

ROW12: Need to cite the dedication of ROW to the county along Tejon by he original platting.

ROW13: The addressing will be provided for Final Plat of the private access tracts B, C, and D once street names have been researched. Lots 1 and 2 will be addressed off W. 53rd Dr.

Commenting Division: Planning and Development, Engeneering **Name of Reviewer:** Steve Krawczyk, Senior Civil Engineer

Email: MEmmens@adcogov.org / 720-523-6854

ENG1: A Preliminary Drainage Report is required during the rezoning process to show how if the property to be zoned will impact any downstream areas.

ENG2: A traffic analysis will need to be submitted to determine the transportation impacts of the proposed development based on the highest and best use. The analysis should address any off-site improvements that may be necessary to mitigate traffic impacts from the proposed development. The traffic study only included calculations for any impact for the intersections one mile or less for the highest possible intensity uses from this site with the plat submittal.

ENG3: The applicant needs to be aware that prior to building permit and/or lot sale a Plat is required in conformance with the Adams County Development Manual. Access location requirements will be determined at time of final plating. Additional improvements such as turn lanes, signage and striping will be required with the submittal of the EGR and Plat. Any design and construction standards shall be in accordance with the Adams County Development Manual and be determined during the platting process.

EGR4: Access for the subdivision must take access point private drive off Raritan Way or other street internal to the subdivision. This access location is acceptable. Additional improvements such as a left turn will be addressed at time of platting.

EGR5: The graphic drawings contained a note that the PDP submitted for this site is intended to depict general locations of improvements. During the platting process the County establish the following A. Final road alignments

B. Final configuration of lot and tract sizes and shapes

- C. Final building envelopes
- D. Final access and parking locations
- E. Landscaping adjustments

Sheet Title

COVER SHEET

NARRATIVE & STANDARDS

SITE PLAN

LOT TYPICAL & STREET SECTIONS

PRELIMINARY LANDSCAPE,

CIRCULATION & FENCING

OPEN SPACE DIAGRAM

ARCHITECTURAL ELEVATIONS

SHEET INDEX

Sheet Number

2

3

4

5

6

7

8

9

10

11

12

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14

15

16

17

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N THE

Prepared For COTTAGES Contact: Chase Stillman chase.stillman@oreadcapital.com

■ Land Planning ■

pcs group

www.pcsgroupco.com p.o. box 18287 denver, co 80218 † 303.531.4905 . f 303.531.4908

■ Civil Engineering



999 18th Street, Suite 2110 Denver, CO

ELOPMENT **DEVELOPMENT PLAN** DEVELOPMENT ED Δ PLANNED UNIT **PRELIMINARY**

Issue Date: 09/21/22

Issue For:

2nd PUD/PDP Submittal

NOT FOR CONSTRUCTION

REVISIONS:		DATE:
1		XX/XX/XX
2		
3		
4		

■ Sheet Name ■

COVER SHEET

■ Sheet Number ■

18 of


RARITAN ESTATES REDEVELOPMENT

A REPLAT OF LOTS 1-6 AND TRACT A, RARITAN ESTATES SUBDIVISION LOCATED IN THE NORTHWEST QUARTER OF SECTION 16, TOWNSHIP 3 SOUTH, RANGE 68

> WEST, 6TH PRINCIPAL MERIDIAN COUNTY OF ADAMS, STATE OF COLORADO

PLANNED UNIT DEVELOPMENT / PRELIMINARY DEVELOPMENT PLAN

VICINITY MAP

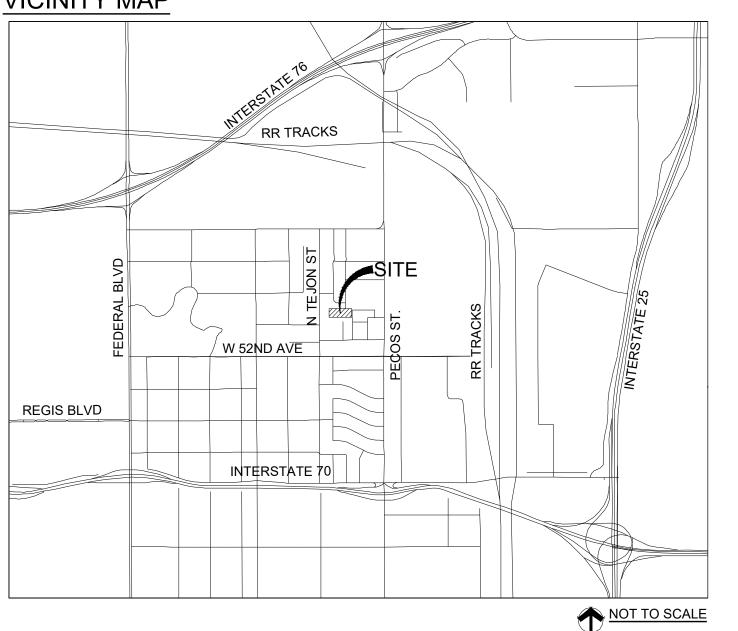

LEGAL DESCRIPTION

The legal description must match that of the title commitment CUUNTT OF ADAMS, STATE OF COLORADO.

UPDATED TO MATCH TITLE

CERTIFICATE OF OWNERSHIP

PASCUAL CARILLO & ANA CARRILLO, BEING THE OWNERS OF 5350 TEJON STREET, LOCATED IN THE COUNTY OF ADAMS, STATE OF COLORAD, HEREBY SUBMITS THIS PLANNED UNIT DEVELOPMENT -PRELIMINARY DEVELOPMENT PLAN AND AGREES TO PERFORM UNDER THE TERMS NOTED HERON.

OWNER: This signature/approval block must be formatted the same as provided on the OWNER: UPDATED TO MATCH Subdivision plat PLAT STATE: COUNTY: CITY: THE FOREGOING INSTRUMENT WAS ACKNOWLEDGED BEFORE ME THIS ____DAY OF ___ NOTARY PUBLIC

BOARD OF COUNTY COMMISSIONS APPROVAL

PLANNING COMMISSION APPROVAL RECOMMENDED FOR APPROVAL BY THE ADAMS COUNTY PLANNING COMMISSION THIS DAY OF A.D. 202_

MY COMMISSION EXPIRES:

ADAMS COUNTY ATTORNEY'S OFFICE

APPROVED AS TO FORM Order of appearance for signature/approval blocks:

CHAIR **BOARD OF COUNTY COMMISSIONERS' APPROVAL**

APPROVED BY THE ADAMS COUNTY BOARD OF COUNTY COMMISSIONERS THIS _ A.D. 202_

Owner Surveyor

Planning Commission **Board of County Commissioners**

County Attorney

UPDATED TO MATCH

DEVELOPER

URBAN COTTAGES, LLC 10657 E IDA AVENUE ENGLEWOOD, CO 80111 PHONE: 717.875.3961 CHASE STILLMAN

PLANNER/LANDSCAPE ARCHITECT

PCS GROUP, INC. PO BOX 18287 **DENVER, CO 80126** PHONE: 303.531.4985 **ALAN CUNNINGHAM**

CIVIL ENGINEER

CAGE CIVIL ENGINEERING 999 18TH ST, SUITE 2110 **DENVER, CO 80202** PHONE: 720.206.6625 **ERIC PEARSON**

SURVEYOR

EMK CONSULTANTS, INC. 7006 SOUTH ALTON WAY, BLDG. F CENTENNIAL, CO 80112 PHONE: 303.694.1520 STEPHEN HARDING

ARCHITECT

GODDEN SUDIK 5975 S. QUEBEC ST. CENTENNIAL, CO 80111 303.455.4437 **ALEX JEWETT**

■ Prepared For

p.o. box 18287

denver, co 80218

† 303.531.4905 . f 303.531.4908

ENT

Issue Date: 09/21/22

Issue For:

2nd PUD/PDP Submittal

NOT FOR CONSTRUCTION

R	EVISIONS:	DATE:
1		XX/XX/XX
2		
3		
4		

■ Sheet Name ■

NARRATIVE & **STANDARDS**

■ Sheet Number ■

18

EXPLANATION OF THE CHARACTERISTICS OF THE PUD

THE PUD-PDP PROPOSES THE DEVELOPMENT OF 16 SINGLE FAMILY DETACHED RESIDENTIAL HOMES LOCATED ON SEVERAL PARCELS TOTALING APPROXIMATELY 2.04 ACRES. THE SITE CONSISTS OF PREDOMINANTLY VACANT, UNDEVELOPED LAND. PROPOSED RESIDENTIAL LOTS WILL BE MIN. 2,400 SF. THE PROJECT WILL INCLUDE PASSIVE AND ACTIVE LANDSCAPED AREAS AND PRIVATE DRIVES. PRIMARY SITE ACCESS WILL BE PROVIDED WITH PROPOSED PRIVATE DRIVE CONNECTIONS TO TEJON ST. AND RARITAN WAY. HOMES WILL BE REAR-LOADED WITH GARAGE ACCESS TO ALLEYS. HOMES WILL FRONT TO LANDSCAPED OPEN AREAS. INTERNAL WALKS WILL PROVIDED PEDESTRIAN MOVEMENT TO FRONT DOORS, ACTIVE OPEN SPACE AND ADJACENT

NARRATIVE & DEVELOPMENT STANDARDS

THE ABUTTING NEIGHBORHOODS TO THE NORTH, WEST AND SOUTH ARE ZONED R-1-C. THE NEIGHBORHOOD TO THE EAST IS ZONED R-3. A CONCURRENT REZONE APPLICATION IS BEING SUBMITTED ALONG WITH THIS PUD-PDP TO PERMIT THE DEVELOPMENT OF THE PROPOSED RESIDENTIAL PRODUCT TYPE.

POTENTIAL IMPACT ON THE SURROUNDING AREA

THE PROPOSED DEVELOPMENT IS CONSISTENT WITH THE ADAMS COUNTY 2012 UPDATE TO THE COMPREHENSIVE PLAN. THE PROJECT WILL PROVIDE A UNIQUE HOUSING OPPORTUNITY THAT ADDRESSES THE CURRENT NEED FOR HIGHER DENSITY, MARKET ATTAINABLE SINGLE-FAMILY HOMES. PROPOSED HOME MASSING, HEIGHT LIMITS AND EXTERIOR ARCHITECTURE WILL BE COMPLIMENTARY TO EXISTING ADJACENT RESIDENCES. PEDESTRIAN CONNECTIONS WILL PROVIDE GREATER ACCESS TO THE REST OF THE COMMUNITY. EXISTING UTILITY AND INFRASTRUCTURE HAS CAPACITY TO ACCOMMODATE THE DEVELOPMENT.

CONTEMPLATED DENSITIES AND LAND COVERAGE

THIS PDP-PUD CONSISTS OF 16 DWELLING UNITS WHICH A PROVIDE A DENSITY OF 7.8 DU/AC. RESIDENTIAL LOTS WILL ACCOUNT FOR 20% OF THE SITE. OPEN AREAS SUCH AS ALLEYS, ACCESS DRIVES AND COMMON OPEN SPACE AREAS WILL MAKE UP 80% OF THE SITE.

CIRCULATION AND ROAD PATTERNS

A 24' PRIVATE DRIVE (RARITAN WAY) WILL PROVIDE INTERNAL ACCESS AND INTERSECT WITH TEJON STREET AND RARITAN WAY. THIS DRIVE WILL DEAD END AT THE EASTERN EDGE OF THE PROPERTY.ALLEYS | Must include maintenance of all | ACCESS TO UNITS.

RACTS (Private drives/alleys,

common area, detention LANDSCAPE MAINTE location)

NSIBLE FOR THE ENFORCEMENT OF PRIVATE OPEN SPACE TRACTS,

COMMON AREAS AND MAINTENANCE OF ALL PRIVATE PRIVES COUNTY MAINTENANCE RESPONSIBILITI County will not maintain private drives/alleys OF THE PAVEMENT AND CURB AND within the subdivision. This must be revised GRAFFITI, SNOW, ICE, SLEET, DEBRIS or stricken. RESPONSIBLE FOR MAINTAINING THE STRUCTURAL INTEGRITY OF THE SIDEWALKS WITHIN STREET

COUNTY WILL BE

RIGHTS-OF-WAY.

LOCATION AND TYPES OF LANDSCAPE MAINTENANCE PROVISIONS THE PROJECT WILL INCLUDE PRIVATE DRIVES & ALLEYS, PRIVATE OPEN SPACE TRACTS WITH ACTIVE & PASSIVE USE AND ON-LOT RESIDENTIAL LANDSCAPE AREAS. INSTALLATION OF LANDSCAPE TRACTS AND THEIR AMMENITIES SHALL BE THE RESPONSIBILITY OF THE DEVELOPER/HOME BUILDER. MAINTENANCE OF THE TRACTS AND AMMENITIES SHALL BE THE RESPONSIBILITY OF AN HOA. THIS this one states HOA and the SNOW REMOVAL FRONT YARD LANDSCAPING OF RESabove a Master Community EVELOPER/HOME BUILDER. RESIDENTIAL FRONT YAR Association. Clarify AREAS. RESIDENTIAL LOTS WILL ALSO INCLUDE PRIVATE, FENCED SIDE YARDS. SHARED USE AREAS WILL BE PROVIDED WITHIN THE MAJORITY LOTS ALLOWING ADDITIONAL OUTDOOR USABLE AREAS IN SIDE YARDS. LANDSCAPE INSTALLATION AND MAINTENANCE OF FRONT YARD LANDSCAPING SHALL BE THE RESPONSIBILITY OF THE HOME/BUILDER DEVELOPER. RESIDENTIAL FRONT YARD TYPICALS ARE INCLUDED WITH THIS PDP/PUD. RESIDENTIAL SIDE YARDS AND LANDSCAPE ADJACENT TO ALLEYS SHALL BE INSTALLED AND MAINTAINED BY THE HOMEOWNER

SERVICE PROVIDERS

- NORTH LINCOLN WATER AND SANITATION DISTRICT
- XCEL ENERGY GAS & ELECTRIC SERVICE
- COMCAST/XFINITY
- ADAMS COUNTY FIRE RESCUE

COVENANTS TO BE IMPOSED ON THE PUD

COVENANTS, CONDITIONS AND RESTRICTIONS (CC&R'S) SHALL BE IMPOSED ON THIS PUD AND WILL BE ENFORCED BY AN HOA ESTABLISHED WITH THIS DEVELOPMENT.

ARCHITECTURE

THESE HOMES CONSIST OF THREE TWO-STORY PLANS THAT RANGE IN SIZE FROM 1,500 TO 1,700 SQUARE FEET AND HAVE A VARIETY OF ELEVATION STYLES. THE ELEVATIONS BOAST FARMHOUSE AND CRAFTSMAN STYLE ELEMENTS WITH A MODERN TWIST. THE HOMES ARE DESIGNED AS AN ALLEY LOADED PRODUCT THAT FEATURE FULL FRONT PORCHES, OPEN FLOOR PLANS, AND FULL BASEMENTS. THE HOMES ALSO OFFER FLEXIBILITY IN THE PLANS WITH OPTIONS FOR ADDITIONAL BEDROOMS, STUDIES, OR LOFTED SPACES. WITH AN ALLEY LOADED GARAGE THE FRONT ELEVATIONS ARE MORE ATTRACTIVE AND OPEN UP TO A GREEN SPACE OR A STREET. WITH LARGER FRONT PORCHES AND SMALL SIDE YARDS, THE OUTDOOR LIVING IS MAXIMIZED ON THESE SMALLER LOTS. BUYERS CAN CHOOSE TO HAVE A FULLY COVERED OR PARTIALLY COVERED FRONT PORCH TO MAXIMIZE SOLAR ORIENTATION, ADDITIONALLY, THE FRONT PORCHES ARE DESIGNED WITH RAILINGS THAT ADD ARCHITECTURAL INTEREST AND PROVIDE A SENSE OF PRIVACY WHILE ALSO ALLOWING HOMEOWNERS AN OPPORTUNITY TO ENGAGE WITH NEARBY NEIGHBORS.

ADDITIONAL CONTROLS SUCH AS ARCHITECTURAL CONTROL COMMITTEE OF A HOMEOWNERS ASSOCIATION NONE AT THIS TIME

K. SIGNAGE

NONE AT THIS TIME

ACCESSORY STRUCTURES

ACCESSORY STRUCTURES ARE NOT PERMITTED.

FENCING SHALL BE PERMITTED BETWEEN LOTS AS DEPICTED IN THIS DOCUMENT. FENCING LOCATIONS AND TYPES HAVE BEEN PROVIDED WITH THIS PUD-PDP. FINAL LOCATIONS SHALL BE PROVIDED WITH FDP.

N. ESTIMATED TIMETABLE FOR CONSTRUCTION & PHASING

THE PROJECT SHALL BE COMPLETED IN A SINGLE PHASE WITH AN ESTIMATED TIME OF CONSTRUCTION COMMENCING IN 2023.

O. SIDE YARD USE EASEMENTS

SIDE YARD USE EASEMENTS ARE HEREBY GRANTED ALONG ALL COMMON SIDE LOT LINES WITHIN ALL ALLEY LOADED DETACHED HOME LOTS AS NOTED ON THE SITE PLAN. SIDE YARD USE EASEMENTS OCCUR FROM FRONT PROPERTY LINE TO REAR PROPERTY LINE AND EXTEND FROM THE GRANTOR'S BUILDING FOUNDATION TO THE LOT LINE BETWEEN THE GRANTOR'S AND GRANTEE'S PARCELS THAT SHALL BE GRANTED TO THE EASEMENT GRANTEE PER THE RESTRICTIONS OUTLINED BELOW. REFER TO FIGURE 1 FOR A GRAPHIC REPRESENTATION OF THE SIDE YARD USE EASEMENT. THE FOLLOWING RESTRICTIONS APPLY TO THE SIDE YARD USE **EASEMENTS**:

THE FOLLOWING RESTRICTIONS APPLY TO THE SIDE YARD USE EASEMENTS:

A. EASEMENT GRANTEE SHALL HAVE FULL ACCESS AND ENJOYMENT OF THE EASEMENT INCLUDING CONSTRUCTION OF IMPROVEMENTS, USE, AND MAINTENANCE OF THE SPACE INCLUDED IN THE EASEMENT.FENCES AND WALLS USED AS PRIVACY SCREENS MAY NOT ENCROACH INTO THE FRONT AND REAR SETBACK. IMPROVEMENTS INCLUDING BUT NOT LIMITED TO DECKS, PATIOS, LANDSCAPING, WALLS, FENCES, RAILS, FURNITURE AND SIMILAR ELEMENTS ARE PERMITTED WITHIN THE DEFINED SIDE YARD USE EASEMENT.DECKS, PATIOS AND WALLS, OTHER THAN PRIVACY SCREENS, IN EXCESS OF 30-INCHES IN HEIGHT (AS MEASURED FROM FINISHED GRADE) ARE NOT PERMITTED IN SIDE YARD USE EASEMENTS. ONLY LANDSCAPING, HARDSCAPE, AND IRRIGATION IMPROVEMENTS ARE PERMITTED WITHIN FRONT AND REAR SETBACKS. NO IMPROVEMENTS MAY BE IMPLEMENTED AT THE DETRIMENT OF THE GRANTOR'S ABILITY TO MAINTAIN THEIR HOME.

B. SIDE YARD USE EASEMENTS ARE PERMITTED ON DETACHED SINGLE FAMILY LOTS AS DEPICTED ON THE FINAL PLAT.

C. ALL IMPROVEMENTS BY GRANTEE LOCATED WITHIN THE SIDE YARD USE EASEMENT SHALL BE MAINTAINED BY THE EASEMENT GRANTEE.

D. EASEMENT GRANTOR IS ENSURED OF ACCESS WITHIN THIS EASEMENT FOR MAINTENANCE AND REPAIR OF THE PRINCIPLE STRUCTURE LOCATED ON THE EASEMENT GRANTOR'S LOT AND FOR NO OTHER PURPOSE.

E. ALL PRINCIPAL STRUCTURES, INCLUDING GARAGES, OWNED BY EASEMENT GRANTOR SHALL BE MAINTAINED BY EASEMENT GRANTOR.

F. SIDE SETBACKS MAY BE REDUCED TO NO LESS THAN 3' AS MEASURED FROM THE FINISHED MATERIAL OF THE EXTERIOR WALL TO THE PROPERTY LINE. WHEN REDUCED TO LESS THAN 5' AS MEASURED FROM THE FINISHED MATERIAL OF THE EXTERIOR WALL TO THE PROPERTY LINE, THE THEN CURRENT IBC AND/OR IRC CODE REQUIREMENTS AND AMENDMENTS WITHIN THE GOVERNING MUNICIPALITY WILL BE ENFORCED WITH REGARD TO EXTERIOR WALL FIRE-RESISTANT RATING AND MINIMUM FIRE-SEPARATION DISTANCE REQUIREMENTS.

G. GRANTEE SHALL NOT ALTER FINISHED GRADE AND/OR DRAINAGE PATTERNS ON THE GRANTOR'S PROPERTY WITHOUT THE WRITTEN APPROVAL OF THE DESIGN REVIEW COMMITTEE.

ALLEY LOADED GARAGE: A GARAGE WITH THE VEHICULAR DOOR ACCESS LOCATED ONTO AN ALLEY LOCATED AT THE REAR (OR SOMETIMES SIDE) OF THE LOT.

EASEMENT GRANTOR: THE LOT OWNER GRANTING SIDE YARD AREA TO ADJACENT LOT

EASEMENT GRANTEE: THE LOT OWNER GAINING SIDE YARD AREA FROM ADJACENT LOT

Q. PROVISIONS FOR PARKING

A MINIMUM OF TWO OFF-STREET RESIDENTIAL GARAGE PARKING SPACES WILL BE PROVIDED WITHIN EACH HOME. PARALLEL SPACES ARE PROVIDED ALONG RARITAN WAY. PARKING WILL NOT BE PERMITTED WITHIN THE ALLEYS AND SHALL BE SIGNED AS SUCH.

R BIJLK & DIMENSION STANDARDS

N. DOLK & DIMILITATION STANDARDS	
MIN. LOT SIZE	2,400 SF.
MIN. LOT WIDTH	32'
MAY BUILDING HEIGHT (2 CTORIES)	251
MAX. BUILDING HEIGHT (2-STORIES)	35'
MINIMUM SETBACKS	
BUILDING TO FRONT LOT LINE	5'-0"
BUILDING TO ALLEY FLOW LINE	5'-0"
BUILDING SIDE TO ALLEY/PRIVATE DRIVE FLOWLINE	10'-0"
BUILDING SIDE TO LOT LINE	5'-0"
BUILDING TO BUILDING	10'-0"

NOTE: SETBACKS ARE MEASURED FROM BUILDING FOUNDATIONS

PERMITTED SETBACK ENCROACHMENTS	
EAVES, OVERHANGS , BAY WINDOWS	1'-0"
WINDOW WELLS, COUNTERFORTS	2'-0"
EXTERIOR SIDING, VENEER, BRICK, STONE	0'-4"

PARKING SUMMARY		
UNITS		16 UNITS
GARAGE PARKING (2 SPACES PER UNIT)		32 SPACES
GUEST SPACES (PARALLEL SPACES)		13 SPACES
	TOTAL	45 SPACES

LANDSCAPING

RIGHT OF WAY AND OPEN SPACE LANDSCAPING SHALL BE PROVIDED IN ACCORDANCE WITH COUNTY STANDARDS. ON-LOT RESIDENTIAL LANDSCAPING SHALL BE PROVIDED AS NOTED BELOW IN CONJUNCTION WITH A WAIVER REQUEST REGARDING REQUIRED FRONT SETBACK TREE PLANTINGS.

ON-LOT RESIDENTIAL LANDSCAPE STANDARDS			
LOCATION	*MIN. TREES	**MIN. SHRUBS	
FRONT SETBACK	N/A	6	
REAR SETBACK	N/A	2	
SIDE SETBACK (INTERNAL LOTS)	N/A	N/A	
SIDE SEBACK (FACING PRIVATE DRIVE) N/A		10	
NOTES:			
*TREES CANNOT BE PLANTED WITHIN RESIDENTIAL LOTS DUE TO CONFLICTS WITH UTILITY EASEMENTS.			
** SHRUBS MAY BE SUBSTITUTED WITH ORNAMENTAL GRASSES AT A RATE OF 3 GRASSES PER REQUIRED SHRUB			

1. PLANT SIZES, TYPES AND SPECIES SHALL CONFORM TO COUNTY PERFORMANCE STANDARDS

WAIVERS

WAIVER NO.	RELEVANT CODE SECTION	WAIVER REQUEST	JUSTIFICATION
1	5-03-02-02-01 (SUBDIVISION DESIGN, IMPROVEMENTS, AND DEDICATION LAND DEDICATION STANDARDS - MINIMUM SETBACKS/BUFFERS TO ACHIEVE COMPATIBILITY)	REQUEST WAIVER PERMITTING LOTS 15 & 16 TO BE CONSTRUCTED CLOSER THAN THE REQUIRED 30' BUFFER ADJACENT TO EXISTING SF. DEVELOPMENT	AN EXISTING SF RESIDENTIAL STRUCTURE IS LOCATED WITHIN THE 30' RESIDENTIAL BUFFER TO THE SOUTH ADJACENT TO PROPOSED LOTS 15 & 16. THIS EXISTING STRUCTURE IS TO BE REMOVED AND REPLACED WITH TWO NEW HOMES WHICH WILL ALSO BE WITHIN THE 30' BUFFER. THE EXISTING AND PROPOSED CONDITIONS WILL NOT BE SUBSTANTIALLY DIFFERENT.
2	5-03-03-10 (SUBDIVISION DESIGN, IMPROVEMENTS, AND DEDICATION LAND DEDICATION STANDARDS - ACCESS TO LOTS BY PRIVATE ROADS)	REQUEST WAIVER PERMITTING THE PLATTING AND CONSTRUCTION OF PRIVATE DRIVES (RARITAN WAY & ALLEYS)	PROPOSED ALLEY AND PRIVATE DRIVE NETWORK MEETS FIRE/LIFE/SAFETY REQUIREMENTS. PROPOSED ROAD NETWORK PROVIDES VEHICULAR CONNECTIVITY WITH A SMALLER SECTION THAN A FULL RIGHT OF WAY.

RARITAN ESTATES SUBDIVISION AMENDMENT NO. 1 PRELIMINARY PLAT

CASE NO. PRC2022-00008

LOCATED IN THE NORTHWEST QUARTER OF SECTION 16, TOWNSHIP 3 SOUTH, RANGE 68 WEST, 6TH PRINCIPAL MERIDIAN, COUNTY OF ADAMS, STATE OF COLORADO

SHEET 1 OF 2

This is a NOTE

NOTE RELOCATED

Provide a Purpose Statement. Redivision of lots and streets within the STATEMENT ADDED original subdivision

DEDICATION AND OWNERSHIP CERTIFICATION

THE UNDERSIGNED DOES HEREBY DEDICATE GRANT AND CONVEY TO ADAMS COUNTY THOSE PUBL Know all men by these presents that (owner N ON THE PLAT; AND FURTHER RESTRICTS Ti name(s)), being the sole owner of the following ADAMS COUNTY AND/OR ITS ASSIGNS, PR described tract of land: HT AND AUTHORITY TO RELEASE OR QUITCLAIN DEDICATION REWORDED TS SHALL REMAIN EXCLUSIVELY VESTED IN ADAMS COUNTY.

REVISED ACCORDINGLY

RARITAN WAY IS TO BE PRIVATELY OWNED AND MAINTAINED BY UC TEJON, LLC. AND THE HOME OWNER'S ASSOCIATION. NOTE RELOCATED

LEGAL DESCRIPTION

KNOW ALL MEN BY THESE PRESENTS THAT THE UNDERSIGNED WARRANTS IT IS THE OWNER OF THE PARCEL OF LAND SHOWN HEREIN, SITUATED IN THE NORTHWEST QUARTER OF SECTION 16, TOWNSHIP 3 SOUTH, RANGE 68 WEST, 6TH P.M., COUNTY OF ADAMS, STATE OF COLORADO, MORE PARTICULARLY DESCRIBED AS FOLLOWS:

PARCEL A:

STATE OF COLORADO

NOTARY PUBLIC _____

LOT 4, RARITAN ESTATES SUBDIVISION, COUNTY OF ADAMS, STATE OF COLORADO

PARCEL B.
All plats with public easements and/or tracts must have the following LOTS sentence in the dedication statement: The undersigned does hereby VISION, COUNTY OF


ADAM dedicate, grant and convey to Adam County those Public Easements (and tracts) as shown on the plat; and further restricts the use of all NTO 16 LOTS, 1 BLOCK, Public Easement to Adams County and/or its assigns, provided N ESTATES SUBDIVISION AMEN however, that the sole right and authority to release or quitclaim all Y OF ADAMS, STATE OF COLC or any such Public Easements shall remain exclusively vested in AS SHOWN FOR PUBLIC UTILI Adams County

STATEMENT REWORDED DWAY AND FLOODPLAIN LIMITS, DRAINAGE AND OTHER PUBLIC PURPOSES AS DETERMINED BY THE COUNTY OF ADAMS.

EXECUTED THIS ______, 2022 A.D. CHASE STILLMAN This needs to be located prior to any <u>OWNER</u> ← UC TEJON, LLC. signature/execution block TITLE TITLE

COUNTY OF ____ THE FOREGOING DEDICATION WAS ACKNOWLEDGED BEFORE ME BY _____

AS _____ OF UC TEJON, LLC, THIS ____ DAY OF _____ ..ACKNOWLEDGED BEFORE ME THIS 2022 A.D. 2022, BY CHASE STILLMAN AS MY COMMISSION EXPIRES _____ MANAGER OF UC TEJON, LLC..

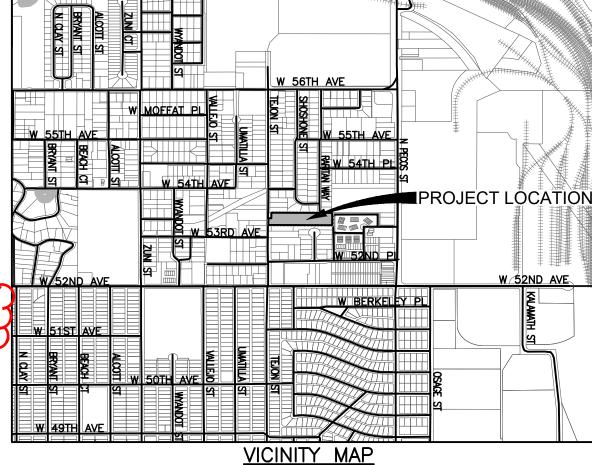

SCALE:1"=1000'

GENERAL NOTES

- 1. NOTICE: ACCORDING TO COLORADO LAW YOU MUST COMMENCE ANY LEGAL ACTION BASED UPON ANY DEFECT IN THIS SURVEY WITHIN THREE (3) YEARS AFTER YOU FIRST DISCOVER SUCH DEFECT. IN NO EVENT MAY ANY ACTION BASED UPON ANY DEFECT IN THIS SURVEY BE COMMENCED MORE THAN TEN (10) YEARS FROM THE DATE OF THE CERTIFICATION SHOWN HEREON.
- 2. BASIS OF BEARINGS: BEARINGS SHOWN HEREON ARE BASED UPON THE NORTHERLY LINE OF RARITAN ESTATES SUBDIVISION WHICH BEARS NORTH 89'48'50" WEST, SAID LINE IS MONUMENTED AS SHOWN HEREIN.
- 3. THE LINEAL UNITS OF MEASURE SHOWN ON THIS SURVEY ARE BASED UPON THE U.S. SURVEY FOOT.
- 4. THIS SURVEY DOES NOT CONSTITUTE A TITLE SEARCH BY EMK CONSULTANTS, INC. To Title Commitment will need to be updated to within 30 GHTS-OF-WAY. OLD REPUBL days of Final Plat approval, or the approval of the D UPON FOR ALL INFORM Preliminary Plat or within 30 days of Final Plat NOTED F RECORD AND RIGHTS-OF-WAY.
- 5. THIS PLAT OF RAR be vacated by separate instrument. This plat can VACATES ALL RIGHTS ESTATES SUBDIVISION vacate it with the correct citations as noted RARITAN THE N LINCOLN DISTRICT EASEMENT IS NOT A PUBLIC 2017000033082. ON EASEMENT OR R-O-W AND WILL BE VACATED BY SEPA COUNTY, COLORADO.
- 6. THE PRIVATE ACCESS DRIVES WILL BE MAINTAINED BT THE SUBDIVIDER, ITS (OK HIS) SUCCESSORS OR ASSIGNS, UNTIL SUCH TIME AS MAINTENANCE OF THE PRIVATE ACCESS DRIVES IS ASSUMED BY THE HOMEOWNERS ASSOCIATION. THE HOMEOWNERS ASSOCIATION Shown as Tracts OR KEEPING THE PRIVATE ACCESS DRIVE PASSABLE A CCESS DRIVES SHALL NOT BE ACCEPTED FOR REVISED ACCORDINGLY NCE BY ADAMS COUNTY IN THE FUTURE. WITH THE SALE OF EACH LOI, THE OWNER SHALL PROVIDE THE PURCHASER(S) A NONEXCLUSIVE PERPETUAL ACCESS EASEMENT OVER THROUGH AND ACROSS THE PRIVATE ACCESS DRIVES, AND ACROSS ANY OFFSITE PRIVATE ROADS THAT CONNECT THIS SUBDIVISION TO A PUBLIC ROAD.

CONTINUED ON NEXT SHEET

REVISED ACCORDINGLY

SURVEYOR'S CERTIFICATE

I, STEPHEN H. HARDING, A PROFESSIONAL LAND SURVEYOR LICENSED TO PRACTICE LAND SURVEYING IN THE STATE OF COLORADO, DO HEREBY CERTIFY THAT THERE ARE NO ROADS, PIPELINES, IRRIGATION DITCHES OR OTHER EASEMENTS IN EVIDENCE OR KNOWN BY ME TO EXIST ON OR ACROSS THE HEREINBEFORE DESCRIBED PROPERTY, EXCEPT AS SHOWN ON THIS PLAT. I FURTHER CERTIFY THE THE SURVEY WAS PERFORMED UNDER MY DIRECT RESPONSIBILITY, SUPERVISION AND CHECKING, AND THAT THIS PLAT ACCURATELY REPRESENTS SAID SURVEY, AND THAT ALL MONUMENTS EXIST AS SHOWN HEREON.

STEPHEN H. HARDING, PLS 29040 COLORADO LICENSED PROFESSIONAL LAND SURVEYOR FOR AND ON BEHALF OF EMK CONSULTANTS, INC.

<u>LEINHOLDER</u>

BY:	BY: NAME
AS: Order of appearance for approval and certification blocks: Owner	
Surveyor STATE Lien Holder	
Planning Commission COUNT Board of County Commissioners	
THE FUNDER ACCORDINGLY	GED BEFORE ME THIS DAY OF
MY COMMISSION EXPIRES NOTARY PUBLIC	
PLANNING COMMISSION APPROVAL RECOMMENDED FOR APPROVAL BY THE ADM COMMISSION THIS DAY OF APPR CHAIR REVISED ACCORDINGLY BY: CHAIR	A.D. 202_ DAY OF
	OVAL COMMISIONERS THIS DAY OF
BY:CHAIR	
ADAMS COUNTY ATTORNEY'S (<u>DFFICE</u>
APPROVED AS TO FORM	

PREPARED BY EMK Consultants, inc. LAND DEVELOPMENT ENGINEERING ■ SURVEYING 7006 SOUTH ALTON WAY, BLDG. F CENTENNIAL, COLORADO 80112-2019 (303)694-1520 www.EMKC.com RARITAN ESTATES SUBDIVISION AMENDMENT NO. 1
DATE PREPARED: SEPTEMBER 15, 2022


PREPARED FOR: UC TEJON, LLC 3465 SOUTH GAYLORD COURT, A304 ENGLEWOOD, COLORADO 80113 ATTN: TODD JOHNSON P.E. SHEET 1 OF

JOB NO. 13297

RARITAN ESTATES SUBDIVISION AMENDMENT NO. 1 PRELIMINARY PLAT

CASE NO. PRC2022-00008

LOCATED IN THE NORTHWEST QUARTER OF SECTION 16, TOWNSHIP 3 SOUTH, RANGE 68 WEST, 6TH PRINCIPAL MERIDIAN, COUNTY OF ADAMS, STATE OF COLORADO

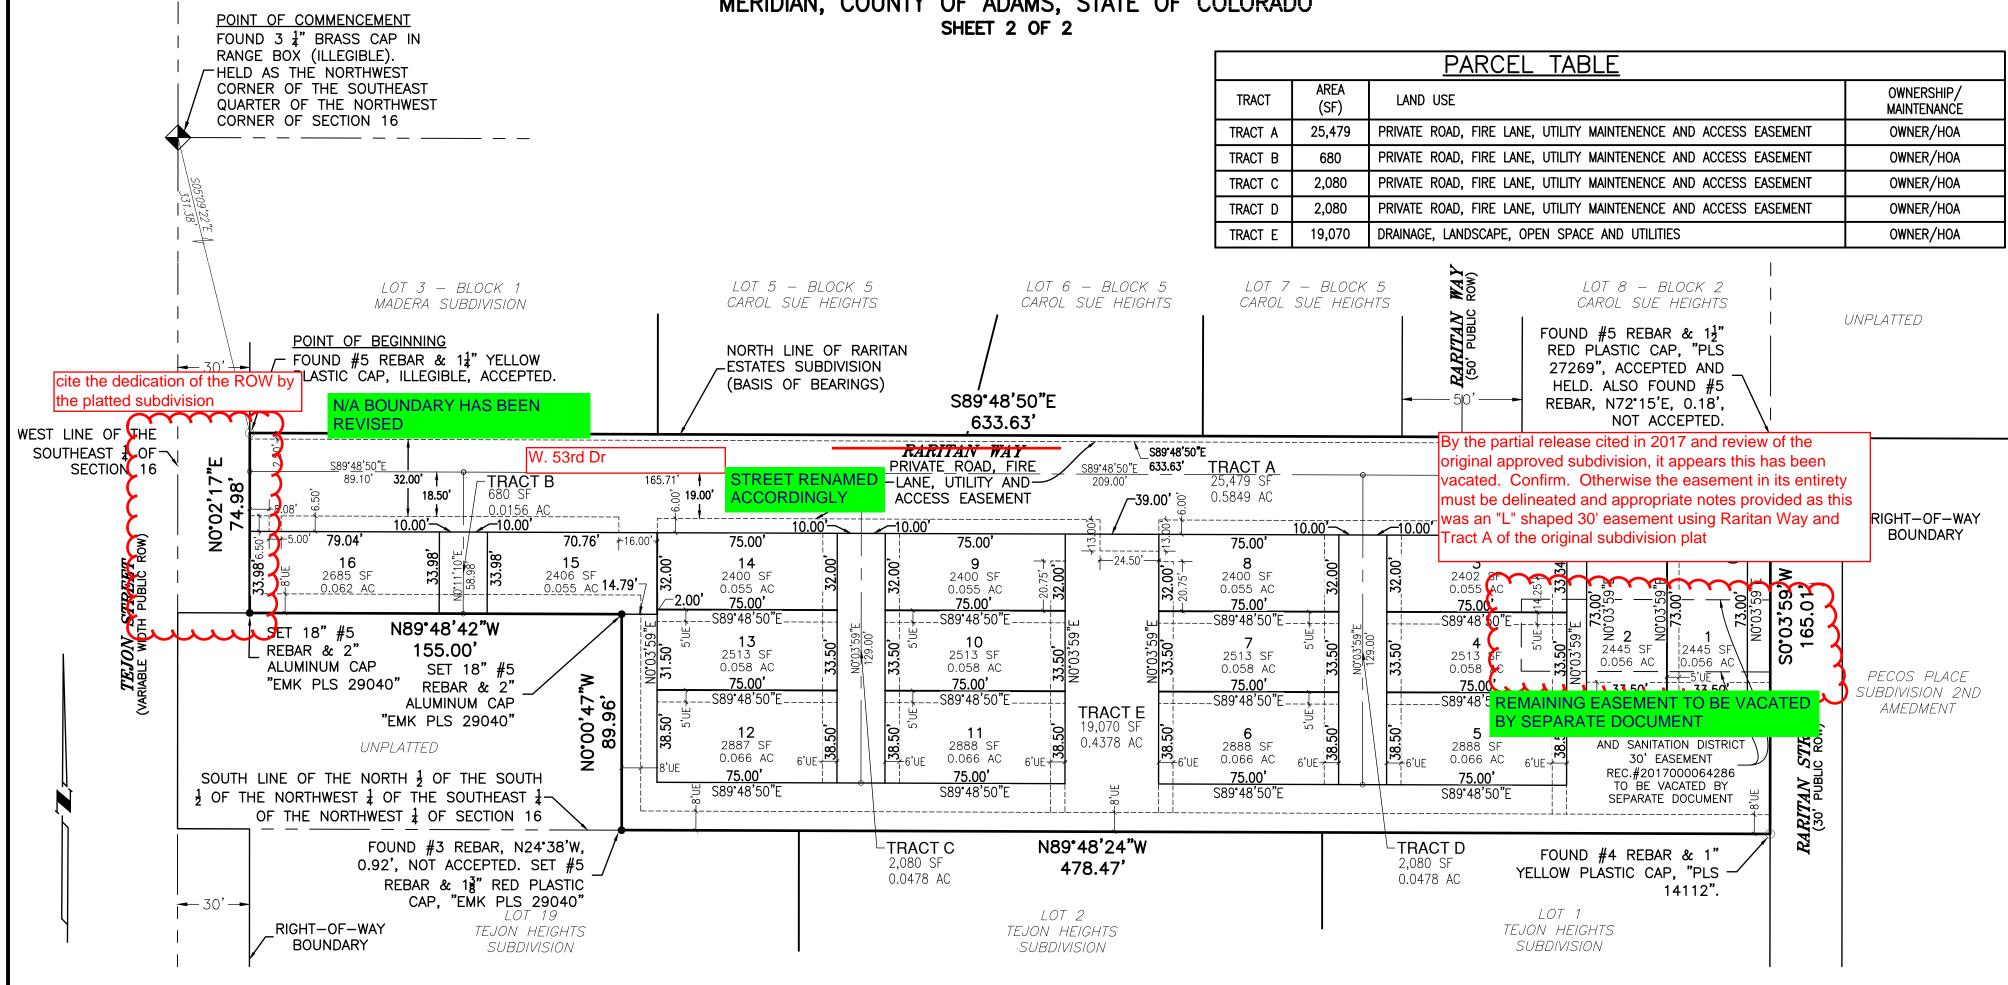



GENERAL NOTES CONTINUED

- 7. Ititle note: STORM DRAINAGE FACILITIES STATEMENT

 CESS BE PROVIDED TO ALL STORM DRAINAGE FACILITIES TO ASSURE ROPERTY OWNERS SHALL BE RESPONSIBLE FOR THE MAINTENANCE OF ALL DRAINAGE FITTLE NOTE ADDED

 ETS, PIPES, CULVERTS, CHANNELS, DITCHES, HYDRAULIC STRUCTURES, AND DETENTION BASINS DOIFIED BY THE SUBDIVISION DEVELOPMENT AGREEMENT. SHOULD THE OWNER FAIL TO ADEQUATELY MAINTAIN SAID FACILITIES, THE COUNTY SHALL HAVE THE RIGHT TO ENTER SAID LAND FOR THE SOLE PURPOSE OF OPERATIONS AND MAINTENANCE. ALL SUCH MAINTENANCE COSTS WILL BE ASSESSED TO THE PROPERTY OWNERS.
- 8. EASEMENTS SHOWN HEREIN ARE DEDICATED TO ADAMS COUNTY FOR THE BENEFIT OF THE APPLICABLE UTILITY PROVIDERS FOR THE INSTALLATION, MAINTENANCE, AND REPLACEMENT OF ELECTRIC, GAS, TELEVISION, CABLE, AND TELECOMMUNICATIONS FACILITIES (DRY UTILITES). UTILITY EASEMENTS SHALL BE GRANTED WITHIN ANY ACCESS EASEMENTS AND PRIVATE STREETS IN THE SUBDIVISION. PERMANENT STRUCTURES, IMPROVEMENTS, OBJECTS, BUILDINGS, WELLS, AND OTHER OBJECTS THAT MAY INTERFERE WITH THE UTILITY FACILITIES OR USE THEREOF (INTERFERING OBJECTS) SHALL NOT BE PERMITTED WITHIN SAID UTILITY EASEMENTS AND THE UTILITY PROVIDERS, AS GRANTEES, MAY REMOVE ANY INTERFERING OBJECTS AT NO COST TO SUCH GRANTEES, INCLUDING VEGETATION. PUBLIC SERVICE COMPANY OF COLORADO (PSCO) AND ITS SUCCESSORS RESERVE THE RIGHT TO REQUIRE ADDITIONAL EASEMENTS AND TO REQUIRE THE PROPERTY OWNER TO GRANT PSCO AN EASEMENT ON ITS STANDARD FORM. WET UTILITIES (WATER, SANITARY SEWER, AND/OR STORM SEWER) SHALL CROSS DRY UTILITY EASEMENTS AT NEAR RIGHT ANGLES.

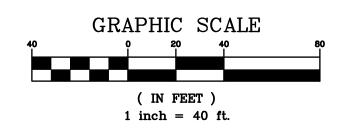

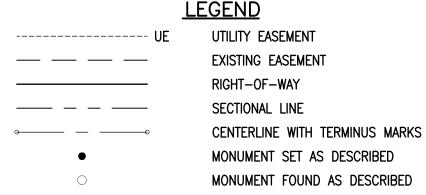



EMK CONSULTANTS, INC.

LAND DEVELOPMENT

ENGINEERING SURVEYING

7006 SOUTH ALTON WAY, BLDG. F
CENTENNIAL, COLORADO 80112-2019
(303)694-1520 www.EMKC.com

JOB NO. 13297

RARITAN ESTATES SUBDIVISION AMENDMENT NO. 1 DATE PREPARED: SEPTEMBER 15, 2022

PREPARED FOR:
UC TEJON, LLC

3465 SOUTH GAYLORD COURT, A304
ENGLEWOOD, COLORADO 80113
ATTN: TODD JOHNSON P.E.

SHEET 2 OF 2

7980 Elmwood Lane Denver, CO 80221 P: (303) 539-6862 E: fireprevention@acfpd.org

Project: Raritan Estates Redevelopment **Type:** County Referral – PRC2022-00008

Address: 5350 Tejon St Date: 7/5/22 SEE PROVIDED COMMENT

Reviewed By: Whitney Even RESPONSE LETTER

The following information provides guidance on general fire code requirements typically applicable to new development projects. However, please be aware that this list is NOT all encompassing. It is the responsibility of the contractor to read this comment letter in its entirety and make sure that all requirements are satisfied.

Comments in blue below are specific to the documents reviewed, but do not require a response.

Comments in red below are specific to the documents reviewed and require a response.

Comments in black are general code requirements that are applicable to this type of project, but do not require a response.


General:

- 1. The 2018 International Fire Code is the current fire code adopted within the city and all development must be in compliance with its requirements. The 2018 IFC can be accessed online for free by going to https://codes.iccsafe.org/public/document/IFC2018. Amendments to this code can be located by going to http://www.adcogov.org/sites/default/files/Ordinance%20No.%204 1.pdf.
- 2. Site and building design and construction shall be in accordance with the provisions of the 2018 International Fire Code (IFC) as adopted by Adams County. All construction shall be in accordance with IFC Chapter 33, Fire Safety During Construction and Demolition.
- **3.** Please be aware that these comments are subject to change as more information is received or if there are changes to the plans during subsequent reviews.

Access Requirements:

- 4. Approved access roads must be constructed prior to any vertical construction and/or to combustible materials being delivered to the site, whichever comes first. Temporary access roads are prohibited unless specifically approved by the Fire District. Fire apparatus access must be designed and maintained to support the imposed loads of fire apparatus (i.e. 85,000 lbs), and must have a surface that provides all-weather driving capabilities. Vehicle access shall be provided to within 150 feet of temporary or permanent fire department connections. Requirement appears to be met on the conceptual plan.
- 5. Fire apparatus access roads shall be a minimum of 24' wide or 26' when a hydrant is present or the building exceeds 30' in height. Raritan Way is shown as 24' wide. However, at least one fire hydrant will need to be installed along this street to provide the appropriate protection to the proposed homes. When hydrants are present, the minimum road width is 26' wide. The proposed alleys are shown at 16' wide. If the alleys exceed 150' in length, the minimum width that may be considered is 20'. If the alleys no not exceed 150' in length, the 16' width may be considered.

- **6.** Fire apparatus access roads shall be within 150' of all ground level exterior portions of the building. Requirement appears to be met on the conceptual plan.
- 7. Any dead-end fire apparatus access road in excess of 150' shall be provided with an approved turnaround. If the alleys create a dead end that is in excess of 150', a turnaround will be required. The plans provided indicate that the alleys are less than 150' in length. Is that correct? On the east end of Raritan Way, another dead end is proposed. The length of this dead end appears to be less than 150' in length. Is that correct?

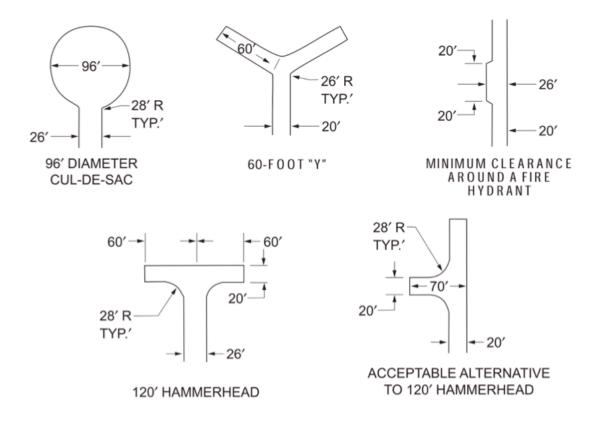

- **8.** Any temporary construction or permanent security gates shall be a minimum of 24 feet and a no parking fire lane sign shall be posted on the gate. The gates shall also have a Knox key switch installed for emergency operation if automatic. **There is an existing gate shown on Raritan Way. Is this gate going to be removed?**
- 9. New and existing buildings shall have approved address numbers, building numbers, or approved building identification placed in a position that is plainly legible and visible from the street or road fronting the property. These numbers shall contrast with their background. Numbers shall be a minimum of 4 inches high with a minimum stroke width of 0.5 inch. Please be aware that the size of the number may need to be larger than 4 inches is not clearly visible from the street or road.
 - a. A temporary sign must be provided if the permanent signage is not yet installed.

Fire Protection Water Supply and Hydrants:

SEE PROVIDED COMMENT RESPONSE LETTER

- **10.** Water mains and all required hydrants shall be installed before the delivery of combustible materials to the site. Hydrants shall be maintained operational at all times thereafter, unless alternate provisions for water supply are approved by the Fire District.
- 11. Unobstructed access to fire hydrants shall be maintained at all times. Fire department personnel shall not be deterred or hindered from gaining immediate access to fire protection equipment or fire hydrants. A 3-foot (radius) clear space shall be maintained around the circumference of fire hydrants. Within that 6-foot diameter circle and within a 6-foot-wide path leading to the 4.5-inch outlet of a hydrant, vegetation shall be no higher than 4 inches above grade. The unobstructed vertical clearance within that 6-foot circle and 6-foot approach path shall not be less than 7 feet, unless otherwise approved by the Fire District.
- **12.** A fire hydrant shall be located within 400' (un-sprinklered building) or 600' (fully sprinkled building) of all ground level exterior portions of the building. **This requirement does not appear to be met. Additional fire hydrants will be required.**
- 13. The number and distribution of fire hydrants is based on the required fire flow. You may refer to Appendix C of the 2018 IFC for guidance. A flow test will need to be performed and show compliance with the table below.

TABLE B105.1(1) REQUIRED FIRE FLOW FOR ONE- AND TWO-FAMILY DWELLINGS, GROUP R-3 AND R-4 BUILDINGS AND TOWNHOUSES			
		MINIMUM FIRE FLOW (gallons per minute)	FLOW DURATION (hours)
0-3,600	No automatic sprinkler system	1,000	1
3,601 and greater	No automatic sprinkler system	Value in Table B105.1(2)	Duration in Table B105.1(2) at the required fire-flow rate
0-3,600	Section 903.3.1.3 of the International Fire Code or Section P2904 of the International Residential Code	500	1/2
3,601 and greater	Section 903.3.1.3 of the International Fire Code or Section P2904 of the International Residential Code	1/2 value in Table B105.1(2)	1
For SI: 1 square foot = 0.0929 m^2 , 1 g	allon per minute = 3.785 L/m.		

Continues on the next page.

TABLE C102.1 REQUIRED NUMBER AND SPACING OF FIRE HYDRANTS^h

FIRE-FLOW REQUIREMENT (gpm)	MINIMUM NUMBER OF HYDRANTS	AVERAGE SPACING BETWEEN HYDRANTS ^{a, b, c, f, g} (feet)	MAXIMUM DISTANCE FROM ANY POINT ON STREET OR ROAD FRONTAGE TO A HYDRANT ^{4,1,9}
1,750 or less	1	500	250
1,751–2,250	2	450	225
2,251–2,750	3	450	225
2,751–3,250	3	400	225
3,251–4,000	4	350	210
4,001–5,000	5	300	180
5,001–5,500	6	300	180
5,501-6,000	6	250	150
6,001–7,000	7	250	150
7,001 or more	8 or more ^e	200	120

For SI: 1 foot = 304.8 mm, 1 gallon per minute = 3.785 L/m.

- a. Reduce by 100 feet for dead-end streets or roads.
- b. Where streets are provided with median dividers that cannot be crossed by fire fighters pulling hose lines, or where arterial streets are provided with four or more traffic lanes and have a traffic count of more than 30,000 vehicles per day, hydrant spacing shall average 500 feet on each side of the street and be arranged on an alternating basis.
- c. Where new water mains are extended along streets where hydrants are not needed for protection of structures or similar fire problems, fire hydrants shall be provided at spacing not to exceed 1,000 feet to provide for transportation hazards.
- d. Reduce by 50 feet for dead-end streets or roads.
- e. One hydrant for each 1,000 gallons per minute or fraction thereof.
- f. A 50-percent spacing increase shall be permitted where the building is equipped throughout with an approved automatic sprinkler system in accordance with Section 903.3.1.1 of the International Fire Code.
- g. A 25-percent spacing increase shall be permitted where the building is equipped throughout with an approved automatic sprinkler system in accordance with Section 903.3.1.2 or 903.3.1.3 of the *International Fire Code* or Section P2904 of the *International Residential Code*.
- h. The fire code official is authorized to modify the location, number and distribution of fire hydrants based on site-specific constraints and hazards.

Other Helpful Information:

- 14. Please be aware that the fire code does not specify building fire rating or set-back requirements. These are located within the building code and therefore are out of our scope. This preliminary review does not approve anything covered under the building code. These requirements need to be verified with the County's Building and Planning Departments.
- **15.** Please be aware that we are a separate entity from the County and anytime you submit to the county, you will need to submit to us separately utilizing our online portal. This link will take you to the online portal: https://go.citygrows.com/acfr-fire-prevention
- **16.** The following reviews and permits are often needed for new development projects:
 - a. Site Development and Water Plans
 - i. Civil Plans
 - ii. Utility Plans
 - iii. Auto-turn Exhibit (use attached apparatus specifications)
 - b. New Construction Building Plans
 - i. Architectural
 - c. Fire Protection System Plans
 - i. Fire Sprinkler (if installed)

SEE PROVIDED COMMENT RESPONSE LETTER **17.** Site development plans must be reviewed and approved before plans for all buildings and fire protection systems are submitted to us for review and permitting. All fees (permit and impact) shall be paid at time of permit pick-up.

SEE PROVIDED COMMENT RESPONSE LETTER



Turning Performance Analysis

09/28/2017

Bid Number: 593

Department: Adams County Fire Rescue

Chassis: Arrow XT Chassis, PAP, PUC

Body: Aerial, Platform 100', PUC, Alum Body

Additional Bumper Depth 94.75 Axie Track Wheel Offset Cramp Angle Tread Width Wheelbase Cino to Cino Turning Radius

r drameters.	
Inside Cramp Angle:	40°
Axle Track:	82.92 in.
Wheel Offset:	5.30 in.
Tread Width:	17.50 in.
Chassis Overhang:	68.99 in.
Additional Bumper Depth:	16.00 in.
Front Overhang:	84.99 in.
Wheelbase:	277.50 in

Calculated Turning Radii:

Inside Turn:	26 ft. 5 in.
Curb to curb:	42 ft. 8 in.
Wall to wall:	49 ft. 0 in.

Comments:

Other Notes:

The front bumper extends 16 inches from the face of the cab.

The width is 19' with outriggers fully extended.

Angle of approach & departure:15 degree

Category Description:	Optionio:	Option Description:
Axle, Front, Custom	0090913	Axle, Front, Oshkosh TAK-4, Non Drive, 24,000 lb, Qtm/AXT/DCF
Wheels, Front	0019618	Wheels, Front, Alcoa, 22.50" x 13.00", Aluminum, Hub Pilot
Tires, Front	0582746	Tires, Front, Goodyear, G296 MSA, 445/65R22.50, 20 ply
Bumpers	0606536	Bumper, 16" Extended, Steel Painted, Arrow XT
Aerial Devices	0592931	Aerial, 100' Pierce Platform, 50 MPH Wind Rating, 150lb Tip Load Allowance
Notes:		

Actual Inside cramp angle may be less due to highly specialized options.

Curb to Curb turning radius calculated for 9.00 inch curb.

SEE PROVIDED COMMENT RESPONSE LETTER



Right of Way & Permits

1123 West 3rd Avenue Denver, Colorado 80223 Telephone: **303.571.3306** Facsimile: 303. 571. 3284 donna.l.george@xcelenergy.com

October 21, 2022

Adams County Community and Economic Development Department 4430 South Adams County Parkway, 3rd Floor, Suite W3000 Brighton, CO 80601

SEE PROVIDED COMMENT RESPONSE LETTER

Attn: Layla Bajelan

Re: 5350 Tejon Final Plat - Raritan Estate Redevelopment - 2nd referral

Case # PRC2022-00008

Public Service Company of Colorado's (PSCo) Right of Way & Permits Referral Desk acknowledges the comment response for the above captioned project, and advises the property owner/developer/contractor to complete the application process as soon as possible via xcelenergy.com/InstallAndConnect for discussion of design details with a Designer.

Additional easements *will* need to be acquired by separate document for new facilities (i.e. transformers) – be sure to contact the Designer and request that they connect with a Right-of-Way Agent.

PSCo requests that the following language or plat note is placed on the preliminary and final plats for the subdivision:

Utility easements are dedicated to Adams County for the benefit of the applicable utility providers for the installation, maintenance, and replacement of electric, gas, television, cable, and telecommunications facilities (Dry Utilities). Utility easements shall also be granted within any access easements and private streets in the subdivision. Permanent structures, improvements, objects, buildings, wells, water meters and other objects that may interfere with the utility facilities or use thereof (Interfering Objects) shall not be permitted within said utility easements and the utility providers, as grantees, may remove any Interfering Objects at no cost to such grantees, including, without limitation, vegetation. Public Service Company of Colorado (PSCo) and its successors reserve the right to require additional easements and to require the property owner to grant PSCo an easement on its standard form.

As a safety precaution, PSCo would like to remind the developer to contact Colorado 811 for utility locates prior to construction.

Donna George
Right of Way and Permits
Rublic Sorvice Company of Colo

Public Service Company of Colorado dba Xcel Energy

Office: 303-571-3306 - Email: donna.l.george@xcelenergy.com



April 13, 2023

Layla Bajelan Planner II-Long Range Planning **Adams County Department of Development Services**

Re: PRC2022-00008; Raritan Estates Redevelopment

Dear Layla,

Thank you for providing review comments regarding the 3rd submittal of the Rezoning, PUD-PDP and Preliminary Plat for the proposed Raritan Estates Redevelopment. Our project team responses have been noted in red below the review comments. This response letter along with updated plans are provided as part of our third submittal of the project.

Please let me know if you have any questions. Thank you for your assistance.

Sincerely,

Liam Hogan, PLA Associate Landscape Architect **PCS Group**

liam@pcsgroupco.com (303) 653-9772





Development Review Team Comments- 2nd Review

Date: 11/04/2022

Project Number: PRC2022-00008

Project Name: Raritan Estates Redevelopment

Note to Applicant:

The following review comments and information from the Development Review Team is based on the information you submitted for a preliminary development plan, preliminary plat, waivers, and vacation. The Development Review Team review comments may change if you provide different information during the next submittal/ building permit. Please contact the case manager if you have any questions. Also, please note where "Section" is referenced, it is referring to the appropriate section of the Adams County Development Standards and Regulations.

Commenting Division: Planning and Development

Name of Reviewer: Layla Bajelan, Senior Long Range Planner

Email: LBajelan@adcogov.org / 720-523-6863

Preliminary Plat

PLN01: All lots appear to meet the minimum lot size and lot width proposed in the PDP

Response: Noted

PLN02: Please switch the PC and BoCC approval blocks so the PC is on top, or before the BoCC.

Response: Revised Accordingly

Preliminary Development Plan

PLN01: Please switch the PC and BoCC approval blocks so the PC is on top, or before the BoCC.

Response: Updated.

PLN02: Remove the Clerk and Recorder signature block, as this is not recorded.

Response: Updated.

PLN04: Include an Attorney's verification signature line, similar to the plat.

Response: Added.

PLN05: The PDP has a lot of information selling the project. This should be removed and included in written justification, that can be provided to the Commissioners during hearing. This is the technical document that property owners and County staff use to review the development and should only contain such information.

Response: Language removed and only provided with the written justification letter.

PLN06: Section A, paragraph 2, please remove the sentence "A CONCURRENT REZONE APPLICATION IS BEING SUBMITTED ALONG WITH THIS PUD-PDP TO PERMIT THE DEVELOPMENT OF THE PROPOSED RESIDENTIAL PRODUCT TYPE." as this does not need to be in this document.

Response: Removed.



PLN07: Page 2, Section E- This shall be completed and have no blanks. Please remove the County maintenance responsibilities from this.

Response: Revised as requested

PLN08: Page 2, Section K- This states no signage at this time, but page 3, note 3 says signage is conceptual. The PDP should set parameters on signs (materials, max height/width, etc.) if any signs will be proposed. This should be done at the time of PDP, but can be modified in the FDP.

Response: There will be no signage provided on site, so no language was provided.

PLN09: Page 2, Section O- Staff has concerns over the side yard use easement. Historically this has been confusing for property owners and makes permitting difficult.

Response: This no longer applies to our site plan.

PLN10: Page 2, Section Q- Please include a minimum percentage of visitor parking in the text.

Response: A minimum percentage of visitor parking was added to the section q.

PLN11: Page 2, Section S- Landscaping can be conceptual at the PDP stage, but staff does have concerns pertaining to screening for adjacent neighbors. Also, you are not requesting a wavier from the front setback tree plantings, so please remove this language. I am not sure what this is in reference to? Response: See comment on screening below. Language on waiver for front setback tree plantings was removed.

3-34-03-01-04 SCREENING REQUIRED: Improvements on the site shall be sight-screened with adequate landscaping so as to provide a compatible visual effect as seen from the adjoining properties. Response: More trees and landscape have been provided between the lots and adjacent residential plan per the concept landscape plan.

PLN12: Page 2, Section T- This should be removed from the PDP and added to the written narrative. Response: Removed and included in written narrative.

PLN13: Page 3- The total acreage in the land use summary does not match what is on page 2, Section A. 2.04 acres vs. 2.08 acres

Response: Revised as requested.

PLN14: Page 3- Please include a table with the parking dimensions. We typically see the parking plans with triangles showing all the parking spaces within the development. The site plan is fine, however a small demonstration of parking in the garage and the street should be shown. For example, how are cars being parked in the garage? Is this tandem or side by side? It is very hard to see the spaces on this site plan and they should be clearly shown.

Response: Parking table updated, and garage parking triangles added

PLN15: Please remove street cross sections (page 4) from the PDP.

Response: Revised as requested

PLN16: Page 5- This is fine if this is the only type of fencing allowed. Please keep in mind that if anyone proposed anything slightly different a PUD amendment would be required.

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Response: Detailing of fence removed from plan and only referencing to fencing provide on site plan as well as the language provided in the Narrative & development standards.

PLN17: Page 6- The percentages for open space and active open space are flipped. 3-34-03-05-06 PERCENTAGE OF OPEN SPACE REQUIRED A minimum of 30% Open Space shall be required in all P.U.D.s or as determined by the Board of County Commissioners.

Response: Percentages were updated and should reflect the proper calculations.

3-34-03-05-03 USE OF OPEN SPACE At least twenty-five percent (25%) of the minimum required open space shall be designated for active recreation purposes, and no more than fifty percent (50%) shall be so utilized, in order to preserve a reasonable proportion of natural areas on the site. The purposes for which open space areas are proposed shall be documented.

Response: Percentages were updated and should reflect the proper calculations.

Page 2 and 3 of the zoning map amendment document should be included in the PDP. It does a much better job of demonstrating the open space. Once again, staff has concerns pertaining to the active open space. While the development may be meeting the percentages, staff feels that the intent of the active open space requirements are not being met. Include parameters on structures.

Response: The open space land summary chart added to Open Space Diagram Page and the open space tabulations reformatted for legibility. The illustrative site plan was added to the submittal.

PLN18: The elevations should also set parameters on materials, etc.

Response: Material legend has been added to elevations

Commenting Division: Development Services, Right-of-Way Agent

Name of Reviewer: David Dittmer

Email: DDittmer@adcogov.org / 720-523-6811

ROW1: Revise Dedication and Ownership Certificate as provided by the application guidelines. This will

be for the opening and closing statements as provided.

Response: Revised Accordingly

ROW2: Raritan Way is not to be continued through the subdivision. It should be labeled as W. 53rd Dr.

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Revise throughout sheets.

Response: Revised Accordingly

ROW3: "OWNER/UC TEJON, LLC" needs to be formatted ahead of the signature block.

Response: Revised Accordingly



ROW4: Signature block should read as:

OWNER: UC TEJON, LLC

CHASE STILLMAN

remove additional information. According to the recoded statement of authority found at Reception

2021000107861 this is the only signatory. There are two blocks. Is there another signatory?

Response: Revised Accordingly

ROW5: Notary Affirmation should read:

...ACKNOWLEDGED BEFORE ME THIS _____DAY OF _____ 2022, BY CHASE STILLMAN AS

MANAGER OF UC TEJON, LLC, a/k/a URBAN COTTEGES TEJON, LLC....

Response: Revised Accordingly

ROW6: The Title Commitment will need to be updated to within 30 days of Final Plat application

submission date or it cannot be approved.

Response: Noted

ROW7: Note 6 appears to contradict the statement and citation as provided in the Title Commitment.

Please review and revise as necessary.

Response: Noted

ROW8: the order of appearance on the plat for acceptance and signature blocks is as follows:

Owner Surveyor

Planning Commission (revise as provided)

Board of County Commissioners Response: Revised Accordingly

ROW9: Need to incorporate the TRACTS that are designated as private roads with public access into

Note 6

Response: Revised as requested

ROW10: Label Note 7: STORM DRAINAGE FACILITIES STATEMENT

Response: Revised as requested

ROW11: Review the sanitation districts partial release and revise statements as necessary. It appears the entire easement was vacated, only a portion of the original easement is shown, and the ALTA provided has it shown in its entirety.

Response: Revised as requested

ROW12: Need to cite the dedication of ROW to the county along Tejon by he original platting.

Response: Revised as requested

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ROW13: The addressing will be provided for Final Plat of the private access tracts B, C, and D once street names have been researched. Lots 1 and 2 will be addressed off W. 53rd Dr.

Response: Acknowledged

Commenting Division: Planning and Development, Engeneering Name of Reviewer: Steve Krawczyk, Senior Civil Engineer

Email: MEmmens@adcogov.org / 720-523-6854

ENG1: A Preliminary Drainage Report is required during the rezoning process to show how if the property to be zoned will impact any downstream areas.

Response: Preliminary Drainage Report included

ENG2: A traffic analysis will need to be submitted to determine the transportation impacts of the proposed development based on the highest and best use. The analysis should address any off-site improvements that may be necessary to mitigate traffic impacts from the proposed development. The traffic study only included calculations for any impact for the intersections one mile or less for the highest possible intensity uses from this site with the plat submittal.

Response: The proposed trip generation for the proposed use are well below any thresholds for impacting any existing infrastructure/ intersections or justification for the need for any additional analysis that would provide the same conclusion.

ENG3: The applicant needs to be aware that prior to building permit and/or lot sale a Plat is required in conformance with the Adams County Development Manual. Access location requirements will be determined at time of final plating. Additional improvements such as turn lanes, signage and striping will be required with the submittal of the EGR and Plat. Any design and construction standards shall be in accordance with the Adams County Development Manual and be determined during the platting process.

Response: Acknowledged

EGR4: Access for the subdivision must take access point private drive off Raritan Way or other street internal to the subdivision. This access location is acceptable. Additional improvements such as a left turn will be addressed at time of platting.

Response: Revised as Requested

EGR5: The graphic drawings contained a note that the PDP submitted for this site is intended to depict general locations of improvements. During the platting process the County establish the following

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- A. Final road alignments
- B. Final configuration of lot and tract sizes and shapes
- C. Final building envelopes
- D. Final access and parking locations
- E. Landscaping adjustments

Response: Acknowledged

200 Kalamath St. Denver, CO 80223



Date: 07/05/22

Project Number: PRC2022-00008

Project Name: Raritan Estates Redevelopment

Note to Applicant:

The following information provides guidance on general fire code requirements typically applicable to new development projects. However, please be aware that this list is NOT all encompassing. It is the responsibility of the contractor to read this comment letter in its entirety and make sure that all requirements are satisfied.

Comments in blue below are specific to the documents reviewed, but do not require a response. Comments in red below are specific to the documents reviewed and require a response. Comments in black are general code requirements that are applicable to this type of project, but do not require a response. Commenting Division: Planning and Development

Reviewed By: Whitney Evan

General:

1. The 2018 International Fire Code is the current fire code adopted within the city and all development must be in compliance with its requirements. The 2018 IFC can be accessed online for free by going to https://codes.iccsafe.org/public/document/IFC2018. Amendments to this code can be located by going to http://www.adcogov.org/sites/default/files/Ordinance%20No.%204 1.pdf.

Response: Acknowledged

2. Site and building design and construction shall be in accordance with the provisions of the 2018 International Fire Code (IFC) as adopted by Adams County. All construction shall be in accordance with IFC Chapter 33, Fire Safety During Construction and Demolition.

Response: Acknowledged

3. Please be aware that these comments are subject to change as more information is received or if there are changes to the plans during subsequent reviews.

Response: Acknowledged

Access Requirements:

4. Approved access roads must be constructed prior to any vertical construction and/or to combustible materials being delivered to the site, whichever comes first. Temporary access roads are prohibited unless specifically approved by the Fire District. Fire apparatus access must be designed and maintained to support the imposed loads of fire apparatus (i.e. 85,000 lbs), and must have a surface that provides all-weather driving capabilities. Vehicle access shall be provided to within 150 feet of temporary or permanent fire department connections. Requirement appears to be met on the conceptual plan.

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Response: No response required.




5. Fire apparatus access roads shall be a minimum of 24' wide or 26' when a hydrant is present or the building exceeds 30' in height. Raritan Way is shown as 24' wide. However, at least one fire hydrant will need to be installed along this street to provide the appropriate protection to the proposed homes. When hydrants are present, the minimum road width is 26' wide. The proposed alleys are shown at 16' wide. If the alleys exceed 150' in length, the minimum width that may be considered is 20'. If the alleys no not exceed 150' in length, the 16' width may be considered. Response: Acknowledged

6. Fire apparatus access roads shall be within 150' of all ground level exterior portions of the building. Requirement appears to be met on the conceptual plan.

Response: No response required

7. Any dead-end fire apparatus access road in excess of 150' shall be provided with an approved turnaround. If the alleys create a dead end that is in excess of 150', a turnaround will be required. The plans provided indicate that the alleys are less than 150' in length. Is that correct? On the east end of Raritan Way, another dead end is proposed. The length of this dead end appears to be less than 150' in length. Is that correct?

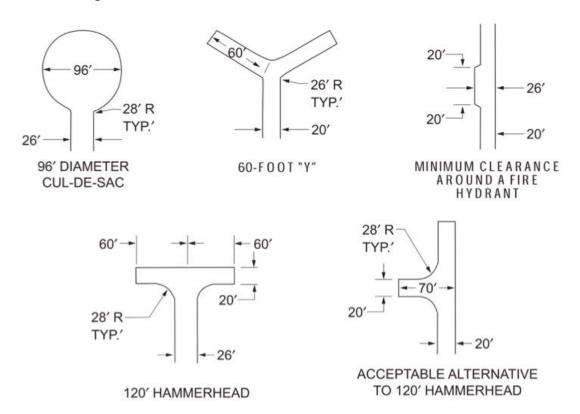

Response: An Acceptable Alternative to 120' Hammerhead has been included in the design, and labelled.

(303) 531-4905

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8. Any temporary construction or permanent security gates shall be a minimum of 24 feet and a no parking fire lane sign shall be posted on the gate. The gates shall also have a Knox key switch installed for emergency operation if automatic. **There is an existing gate shown on Raritan Way. Is this gate going to be removed?**

Response: Acknowledged, existing gate at Raritan Way is to be removed, no permanent gates to remain.

9. New and existing buildings shall have approved address numbers, building numbers, or approved building identification placed in a position that is plainly legible and visible from the street or road fronting the property. These numbers shall contrast with their background. Numbers shall be a minimum of 4 inches high with a minimum stroke width of 0.5 inch. Please be aware that the size of the number may need to be larger than 4 inches is not clearly visible from the street or road. a. A temporary sign must be provided if the permanent signage is not yet installed.

Response: Acknowledged

10. Water mains and all required hydrants shall be installed before the delivery of combustible materials to the site. Hydrants shall be maintained operational at all times thereafter, unless alternate provisions for water supply are approved by the Fire District.

Response: Acknowledged

11. Unobstructed access to fire hydrants shall be maintained at all times. Fire department personnel shall not be deterred or hindered from gaining immediate access to fire protection equipment or fire hydrants. A 3-foot (radius) clear space shall be maintained around the circumference of fire hydrants. Within that 6-foot diameter circle and within a 6-foot-wide path leading to the 4.5-inch outlet of a hydrant, vegetation shall be no higher than 4 inches above grade. The unobstructed vertical clearance within that 6-foot circle and 6-foot approach path shall not be less than 7 feet, unless otherwise approved by the Fire

Response: Acknowledged

District.

200 Kalamath St. Denver, CO 80223

12. A fire hydrant shall be located within 400' (un-sprinklered building) or 600' (fully sprinkled building) of all ground level exterior portions of the building. **This requirement does not appear to be met. Additional fire hydrants will be required.**

Response: Hydrant added to NW corner of site, and another hydrant is near the site at the east in the adjacent apartment complex

13. The number and distribution of fire hydrants is based on the required fire flow. You may refer to Appendix C of the 2018 IFC for guidance. A flow test will need to be performed and show compliance with the table below.



TABLE B105.1(1) REQUIRED FIRE FLOW FOR ONE- AND TWO-FAMILY DWELLINGS, GROUP R-3 AND R-4 BUILDINGS AND TOWNHOUSES

FIRE-FLOW CALCULATION AREA (square feet)	AUTOMATIC SPRINKLER SYSTEM (Design Standard)	MINIMUM FIRE FLOW (gallons per minute)	FLOW DURATION (hours)
0-3,600	No automatic sprinkler system	1,000	1
3,601 and greater No automatic sprinkler system		Value in Table B105.1(2)	Duration in Table B105.1(2) at the required fire-flow rate
0-3,600	Section 903.3.1.3 of the International Fire Code or Section P2904 of the International Residential Code	500	1/2
3,601 and greater	Section 903.3.1.3 of the International Fire Code or Section P2904 of the International Residential Code	1/2 value in Table B105.1(2)	1

For SI: 1 square foot = 0.0929 m², 1 gallon per minute = 3.785 L/m.

TABLE C102.1 REQUIRED NUMBER AND SPACING OF FIRE HYDRANTS^h

FIRE-FLOW REQUIREMENT (gpm)	MINIMUM NUMBER OF HYDRANTS	AVERAGE SPACING BETWEEN HYDRANTS ^{a, b, c, f, g} (feet)	MAXIMUM DISTANCE FROM ANY POINT ON STREET OR ROAD FRONTAGE TO A HYDRANT ^{d, f, g}
1,750 or less	1	500	250
1,751–2,250	2	450	225
2,251–2,750	3	450	225
2,751–3,250	3	400	225
3,251-4,000	4	350	210
4,001–5,000	5	300	180
5,001–5,500	6	300	180
5,501-6,000	6	250	150
6,001–7,000	7	250	150
7,001 or more	8 or more ^e	200	120

For SI: 1 foot = 304.8 mm, 1 gallon per minute = 3.785 L/m.

- a. Reduce by 100 feet for dead-end streets or roads.
- b. Where streets are provided with median dividers that cannot be crossed by fire fighters pulling hose lines, or where arterial streets are provided with four or more traffic lanes and have a traffic count of more than 30,000 vehicles per day, hydrant spacing shall average 500 feet on each side of the street and be arranged on an alternating basis.
- c. Where new water mains are extended along streets where hydrants are not needed for protection of structures or similar fire problems, fire hydrants shall be provided at spacing not to exceed 1,000 feet to provide for transportation hazards.
- d. Reduce by 50 feet for dead-end streets or roads
- e. One hydrant for each 1,000 gallons per minute or fraction thereof.
- f. A 50-percent spacing increase shall be permitted where the building is equipped throughout with an approved automatic sprinkler system in accordance with Section 903.3.1.1 of the International Fire Code.
- g. A 25-percent spacing increase shall be permitted where the building is equipped throughout with an approved automatic sprinkler system in accordance with Section 903.3.1.2 or 903.3.1.3 of the International Fire Code or Section P2904 of the International Residential Code.
- h. The fire code official is authorized to modify the location, number and distribution of fire hydrants based on site-specific constraints and hazards.

Response: Flow test will be provided at the time of Construction Documents

Other Helpful Information:

14. Please be aware that the fire code does not specify building fire rating or set-back requirements. These are located within the building code and therefore are out of our scope. This preliminary review does not approve anything covered under the building code. These requirements need to be verified with the County's Building and Planning Departments.

Response: Acknowledged



15. Please be aware that we are a separate entity from the County and anytime you submit to the county, you will need to submit to us separately utilizing our online portal. This link will take you to the online portal: https://go.citygrows.com/acfr-fire-prevention


Response: Acknowledged

- 16. The following reviews and permits are often needed for new development projects:
- a. Site Development and Water Plans
- i. Civil Plans
- ii. Utility Plans
- iii. Auto-turn Exhibit (use attached apparatus specifications)
- b. New Construction Building Plans
- i. Architectural
- c. Fire Protection System Plans
- i. Fire Sprinkler (if installed)

Response: Acknowledged

17. Site development plans must be reviewed and approved before plans for all buildings and fire protection systems are submitted to us for review and permitting. All fees (permit and impact) shall be paid at time of permit pick-up.

Response: Acknowledged

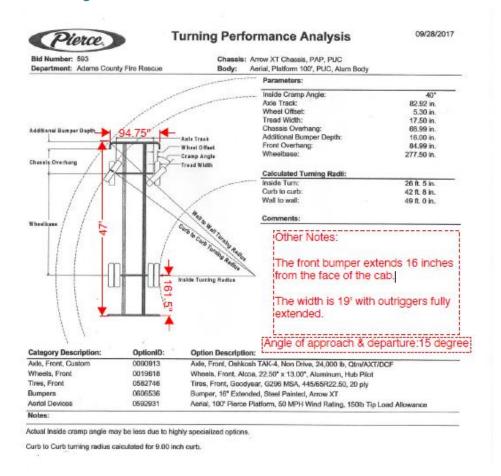

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Right of Way & Permits

1123 West 3rd Avenu

October 21, 2022

Adams County Community and Economic Development Department 4430 South Adams County Parkway, 3rd Floor, Suite W3000 Brighton, CO 80601

Attn: Layla Bajelan

Re: 5350 Tejon Final Plat - Raritan Estate Redevelopment - 2nd referral Case # PRC2022-00008

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Additional easements will need to be acquired by separate document for new facilities (i.e. transformers) - be sure to contact the Designer and request that they connect with a Right-of-Way Agent.

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Donna George Right of Way and Permits

Public Service Company of Colorado dba Xcel Energy

Office: 303-571-3306 – Email: donna.l.george@xcelenergy.com

Response: Acknowledged

200 Kalamath St. Denver, CO 80223